

City of Fitchburg Planning/Zoning Department 5520 Lacy Road Fitchburg, WI 53711 (608-270-4200)

ARCHITECTURAL & DESIGN REVIEW APPLICATION

Applicant/Contact Person: RACE DAY EVENTS	BLAKE HEBERT
Address: 2906 MARKETPLACE DR	Phone Number of Contact Person: 608 - 442 - 6434
	Email of Contact Person: BLAKE HESERT & SUPREMESTIMETURES
Project Address: Corner of Subtreno Plant And South Seminole Hur	
Project Type: Multi-Family Commer	rcial Industrial Other
New Addition	
Impervious Surface Ratio (ISR): 57.8% (City Stan	idard: maximum 65% ISR)
All items listed below must be included with the application application, the applicant must provide in writing the basis Fitchburg Plan Commission for architectural and design r	on to be considered complete. If an item is not included with the s for not including it. Building and site plans submitted to the review shall contain the following information:
5. Existing buildings and 6. Existing and propose 7. Utility plans, including feet of the site 8. ISR shall be indicated 9. Stormwater manager	. oads, drive, etc. res (rivers, ponds, wetlands). d/or improvements. d site drainage. g main/lateral sizes and existing fire hydrants on site or within 300
4. Location of well, septing to the septing of the	s. puildings, improvements and natural features. puildings, improvements and natural features. puildings, improvements and natural features. puictures, including trash/recycling enclosure(s). puictures, including trash/recycling enclosure(s). puictures, etc.). puictures, etc. puictures
3. Number, size, location	uration of drivers and walks.

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 Landscaping: Location, species, size of existing trees, shrubs, and plantings. Location, species, size of proposed plantings. Location and size of all paved, seeded/sodded and gravelled areas. Location of all retaining walls, fences, berms and other landscape features.
It is highly recommended that an applicant hold at least one neighborhood meeting prior to submitting an ADR application to identify any concerns or issues of surrounding residents.
The preceding information is considered to be the minimum information for submission, and the City may require additional information for its review. Any interpretations provided by city officials as the result of submitting the attached information are based on the submitted plans, and any plan changes, may affect the interpretations.
t is the responsibility of the owner/applicant to insure compliance with all local and state requirements. The below signed applicant acknowledges the above information and hereby submits the attached information for the City's Architectural and Design Review Process. Signed: Applicant or Authorized Agent
*** Application shall be accompanied by one (1) sets of full-size plans, two (2) sets no larger than 11"x17", and one (1) pdf document of the complete submittal to planning@fitchburgwi.gov . Applications are due at least 4 weeks prior to the desired Plan Commission Meeting. The time frame assumes a complete set of plans is provided, and if it is not provided the Plan Commission date will be adjusted.
FOR CITY USE ONLY
Date Received: 4 23/19 Plan Commission Date: 5/21/19
Comments:
•



April 23, 2019

To Whom It May Concern:

Race Day Events LLC, Is proposing the construction of their headquarters at the corner or South Seminole Highway and Sub-Zero Parkway. Prior to construction, a bike path along Seminole Highway must be constructed and accepted prior to issuance of permits in accordance with the executed Subdivision Improvement Agreement. The bike path is planned to be constructed in conjunction with Race Day Events Headquarters; therefore, Race Day Events is requesting an early permit which is stated in section 24-14 of the City of Fitchburg's Land Division Ordinance.

The City of Fitchburg Fire Chief will be notified of this project and the proposed plans will be submitted to the Chief for review. Upon Approval of the plan, documentation of the Fire Chiefs Approval will be submitted to the plan commission.

Respectfully,

Dan Bertler

Supreme Structures Inc.

RACE DAY EVENTS FITCHBURG, WI

ARCHITECTURAL DESIGN REVIEW



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DAY

10 ARCHITECTURAL REVIEW Description **Document Release**

Drn:Author

RACE DAY EVENTS DESIGN REVIEW

Sheet Number

T01

General Engineering Company

TITLE PAGE RACE DAY EVENTS SUPREME STRUCTURES



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[14] Elver Park Sub-Zero Group, Military Ridge State Trail Inc. Customer Care NO SCALE **CITY OF FITCHBURG** PROJECT LOCATION LOCATION PLAN

RACE DAY EVENTS

SUPREME STRUCTURES

CITY OF FITCHBURG

DANE COUNTY, WI

PROJECT LOCATION

S. PROS BRADLEY R. BOETTCHER E-34916 PORTAGE,

DRAWN BY ISSUE DATE APRIL 23 2019 GEC FILE NO. 2-1118-526 SHEET NO.

PRELIMINARY NOT FOR CONSTRUCTION

GENERAL

- ALL EXISTING UNDERGROUND UTILITY LOCATIONS SHOWN ARE APPROXIMATE AND SHOULD BE FIELD VERIFIED, BY CONTRACTOR, PRIOR TO CONSTRUCTION.
- 2. ALL ASPHALT REPAIRS/REPLACEMENT SHALL BE SAWCUT TO MATCH EXISTING PAVEMENT AS SHOWN ON THE PLANS OR AS DIRECTED BY THE ENGINEER

WATER MAIN

- EXISTING WATER MAIN LOCATIONS, SIZES, AND TYPES SHOULD BE FIFED VERIFIED BY THE CONTRACTOR PRIOR TO MAKING ANY CONNECTIONS.
- UNLESS OTHERWISE INDICATED BY DESIGN GRADE, MAINTAIN A 7.0' MINIMUM DEPTH OF COVER OVER PROPOSED WATER MAIN AND WATER MAIN LATERALS.
- UNLESS OTHERWISE INDICATED FOR WATER MAIN CROSSINGS BELOW STORM SEWER & SANITARY SEWER PIPES CONTRACTOR SHALL MAINTAIN A MINIMUM 18" OF SEPARATION FROM FDGE OF PIPE TO

SANITARY SEWER & FORCEMAIN

- EXISTING SANITARY SEWER LOCATIONS, SIZES, AND TYPES SHOULD BE FIELD VERIFIED BY THE CONTRACTOR PRIOR TO MAKING ANY CONNECTIONS
- SANITARY SEWER PIPE LENGTHS ARE SHOWN MEASURED FROM INSIDE OF STRUCTURE TO INSIDE OF
- ALL LATERAL CONNECTIONS TO NEW MAIN SHALL BE MADE WITH WYE CONNECTIONS.

STORM SEWER

STORM SEWER PIPE LENGTHS ARE SHOWN MEASURED FROM CENTER OF STRUCTURE TO CENTER OF STRUCTURE

ALL EROSION CONTROL MEASURES SHALL BE IN PLACE PRIOR TO CONSTRUCTION

GRADING & EROSION CONTROL NOTES

- SILT FENCE, TEMPORARY SEDIMENT BASIN, & ROCK CONSTRUCTION ENTRANCE SHALL BE INSTALLED 2. PRIOR TO ANY LAND DISTURBING ACTIVITIES, INCLUDING CLEARING & GRUBBING.
 - ALL STORM SEWER INLETS SHALL HAVE INLET PROTECTION TYPE-D INSTALLED UPON INLET INSTALLATION.
- CONTRACTOR IS RESPONSIBLE FOR WEEKLY DNR INSPECTION REPORTS IN ACCORDANCE WITH NR
- ADDITIONAL EROSION CONTROL MEASURES MAY BE ADDED ON AN AS-NEEDED BASIS. 5.
- THE POND SHALL BE CONSTRUCTED PRIOR TO MASS LAND DISTURBANCE.
- ANY AREAS WHERE GRADING IS COMPLETE SHALL BE STABILIZED WITH FERTILIZER, SEED, & MULCH AS
- ALL BEST MANAGEMENT PRACTICES WILL BE INSTALLED BY THE TIME THE CONSTRUCTION SITE IS 8.
- A COPY OF THIS EROSION CONTROL PLAN SHALL BE KEPT ON SITE THROUGHOUT THE DURATION OF THE
- STOCKPILES LEFT INACTIVE FOR 7 DAYS SHALL BE SEEDED AND SURROUNDED BY SILT FENCE.
- ALL WASTE AND UNUSED BUILDING MATERIALS (INCLUDING GARBAGE, DEBRIS, CLEANING WASTES, OR 11. OTHER CONSTRUCTION MATERIALS) SHALL BE PROPERLY DISPOSED OF AND NOT ALLOWED TO BE CARRIED BY RUNOFF INTO RECEIVING CHANNEL.
- EROSION CONTROL MAT CLASS I, TYPE A WILL BE USED IN NON-CHANNEL AREAS AND CLASS I, TYPE B WILL BE USED IN CHANNEL AREAS
- TRACKED EQUIPMENT ONLY SHALL BE USED IN THE BUFFER AREAS AS TO MINIMIZE COMPACTION.
- STREETS SHALL BE SWEPT AT THE END OF EACH WORK DAY OR AS DIRECTED BY THE MUNICIPALITY.
- TRACKING PADS SHALL BE USED AT THE CONSTRUCTION ENTRANCE AND EXITS.
- ALTHOUGH ROCK CONSTRUCTION TRACKING PADS MAY NOT BE SHOWN ON THE PLANS, THE CONTRACTOR SHALL INSTALL THEM AS NECESSARY OR AS DIRECTED BY THE ENGINEER TO MINIMIZE TRACKING ONTO ADJACENT STREETS. THESE PADS ARE CONSIDERED INCIDENTAL TO THE WORK AND WILL NOT BE MEASURED OR PAID FOR SEPARATELY.
- CONTRACTOR WILL BE RESPONSIBLE FOR ALL DUST CONTROL.
- ALL BANK AREAS DISTURBED SHALL BE STABILIZED WITH EROSION CONTROL MAT IMMEDIATELY.
- 19. POSITIVE DRAINAGE AWAY FROM THE BUILDING WILL BE THE RESPONSIBILITY OF THE CONTRACTOR UNLESS OTHERWISE CONFIRMED BY THE ENGINEER.
- DOWN SPOUTS SHALL BE DIRECTED IN A SAFE MANNER AND COMPLY WITH ALL LOCAL AND STATE
- 21. ALL FILL PLACED UNDER BUILDING AND PAVED AREAS SHALL BE STRUCTURALLY SOUND
- SEDIMENT WILL BE REMOVED FROM BEHIND SEDIMENT FENCES AND BARRIERS BEFORE IT REACHES A DEPTH THAT IS EQUAL TO HALF THE BARRIER'S HEIGHT
- BREAKS AND GAPS IN SEDIMENT FENCES AND BARRIERS WILL BE REPAIRED IMMEDIATELY. DECOMPOSING STRAW BALES WILL BE REPLACED (TYPICAL BALE LIFE IS THREE MONTHS).
- ALL SEDIMENT THAT MOVES OFF-SITE DUF TO CONSTRUCTION ACTIVITY OR STORM EVENTS WILL BE CLEANED UP BEFORE THE END OF THE SAME WORKDAY.
- ALL INSTALLED EROSION CONTROL PRACTICES WILL BE MAINTAINED UNTIL THE DISTURBED AREAS THEY
- ALL EROSION CONTROL MAT SHALL BE INSTALLED WITHIN 24 HOURS OF FINAL GRADES BEING **ESTABLISHED**

EXISTING LINETYPES LEGEND SYMBOLS LEGEND

SANITARY SEWER STORM SEWER -ST-WATER MAIN –FM — FORCE MAIN **ELECTRIC** OVERHEAD ELECTRIC GAS -F0 -FIBER OPTIC TELEPHONE __TV __ FENCE 0 0 0 GUARD RAIL — GL — GL — GL — GRADING LIMITS — SF — SF — SF — SILT FENCE DOUBLE SEDIMENT — DB — DB — DB — BARRIER TRAIN TRACKS

TREELINE

ABBREVIATION LIST

B-B = BACK TO BACK BOC = BACK OF CURB BOP = BOTTOM OF PIPE C-C = CENTER TO CENTER = CENTERLINE = CONTROL POINT DIA = DIAMFTER ELEV = ELEVATION EOG = EDGE OF GRAVEL EOP = EDGE OF PAVEMENT EX = EXISTING FI = FLOW LINE FM = FORCE MAIN HC = HORIZONTAL CURVE HP = HIGH POINT IE = INVERT ELEVATION INL = INLET I = I FNGTH LN = LINE LP = LOW POINT

MH = MANHOLE MIN = MINIMUM MP = MIDPOINT
PC = POINT OF CURVE
PI = POINT OF INTERSECTION PRO = PROPOSED PVT = POINT OF VERTICAL TANGENT

SE = SPOT ELEVATION ST = STORM SEWER STA = STATION STD = STANDARD TC = TOP OF CURB TOW = TOP OF WALL

TYP = TYPICAL

UOS = UNLESS OTHERWISE SPECIFIED

VC = VERTICAL CURVE

W = WATER MAIN SERVICE LATERAL WM = WATER MAIN

 \bigcirc PROPOSED MANHOLE EXISTING HYDRANT PROPOSED HYDRANT

 $(\widehat{S})(\widehat{D})$ EXISTING MANHOLE

VALVE \otimes **CURB STOP**

TRACER WIRE TERMINAL BOX WELL

Compar

Engineering

neral

Ge

4 8 >

PROPERTY CORNER $\bigcirc \Rightarrow$ LIGHT POLE POWER / TELEPHONE POLE

GUY WIRE UTILITY PEDESTAL

ക SIGN • SOIL BORING

MONITORING WELL

Z CAUTION Z POTENTIAL HAZARD BENCHMARK

GEC-CP# CONTROL POINT

DECIDUOUS TREE

INV = INVERT IOS = INSIDE OF STRUCTURE

PRO = PROPOSED
PT = POINT OF TANGENT
PVC = POINT OF VERTICAL CURVE
PVI = POINT OF VERTICAL INTERSECTION
PVMT = PAVEMENT

PYTE POINT OF VERTICAL TANGENT R = RADIUS ROW = RIGHT OF WAY S = SANITARY SEWER SERVICE LATERAL SAN = SANITARY SEWER

CONIFEROUS TREE LEGEND & NOTES
RACE DAY EVENTS
SUPREME STRUCTURES HANDICAP SYMBOL



OWNER

SUPREME STRUCTURES INC. 2906 MARKETPI ACE DR MADISON, WI 53719 PHONE: (608) 224-0777

UTILITIES

1. ELECTRIC MADISON GAS & ELECTRIC

133 S. BI AIR ST. MADISON, WI 53703 PHONE: (608) 252-5618

2. TELEPHONE

PHONE: (608) 252-2432

MADISON GAS & ELECTRIC 133 S. BI AIR ST. MADISON, WI 53703 PHONE: (608) 252-5618

4. CABLE TV CHARTER COMMUNICATION

2701 DANIFLS ST. MADISON, WI 53716 PHONE: (608) 209-3203

5. WATER

CITY OF FITCHBURG 5520 LACY RD. FITCHBURG, WI 53711 PHONE: (608) 270-4200

6. MUNICIPALITY CITY OF FITCHBURG 5520 LACY RD FITCHBURG, WI 53711


PHONE: (608) 270-4200


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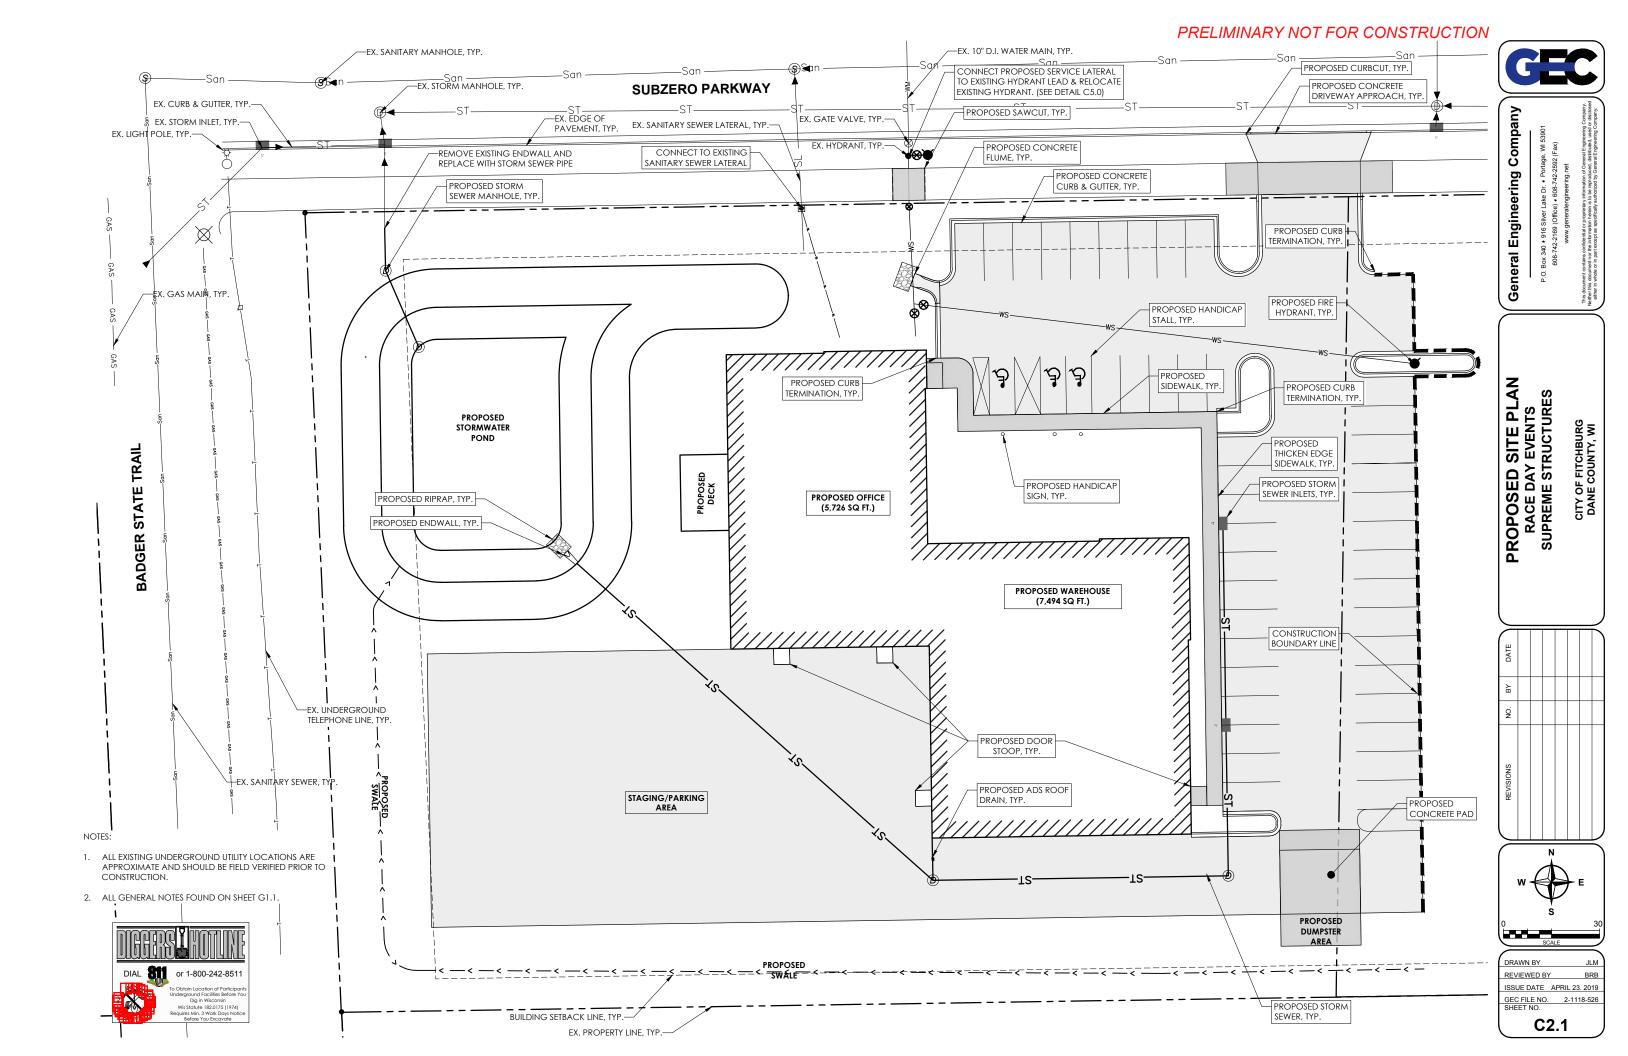
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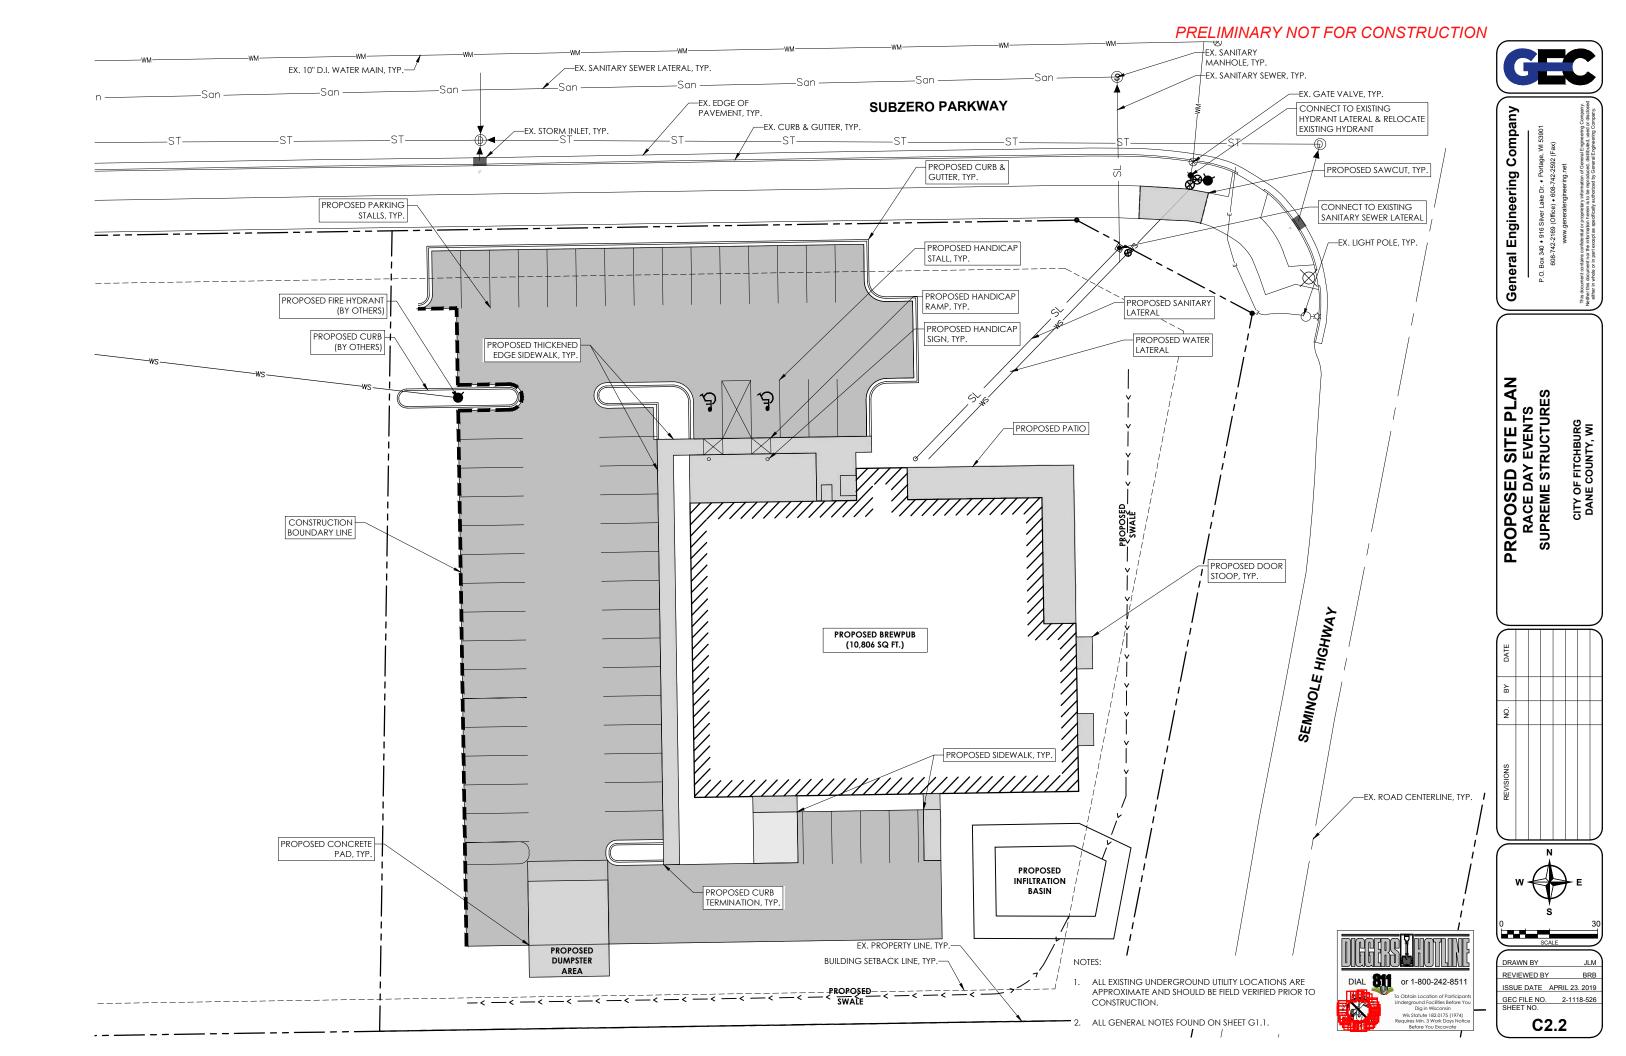
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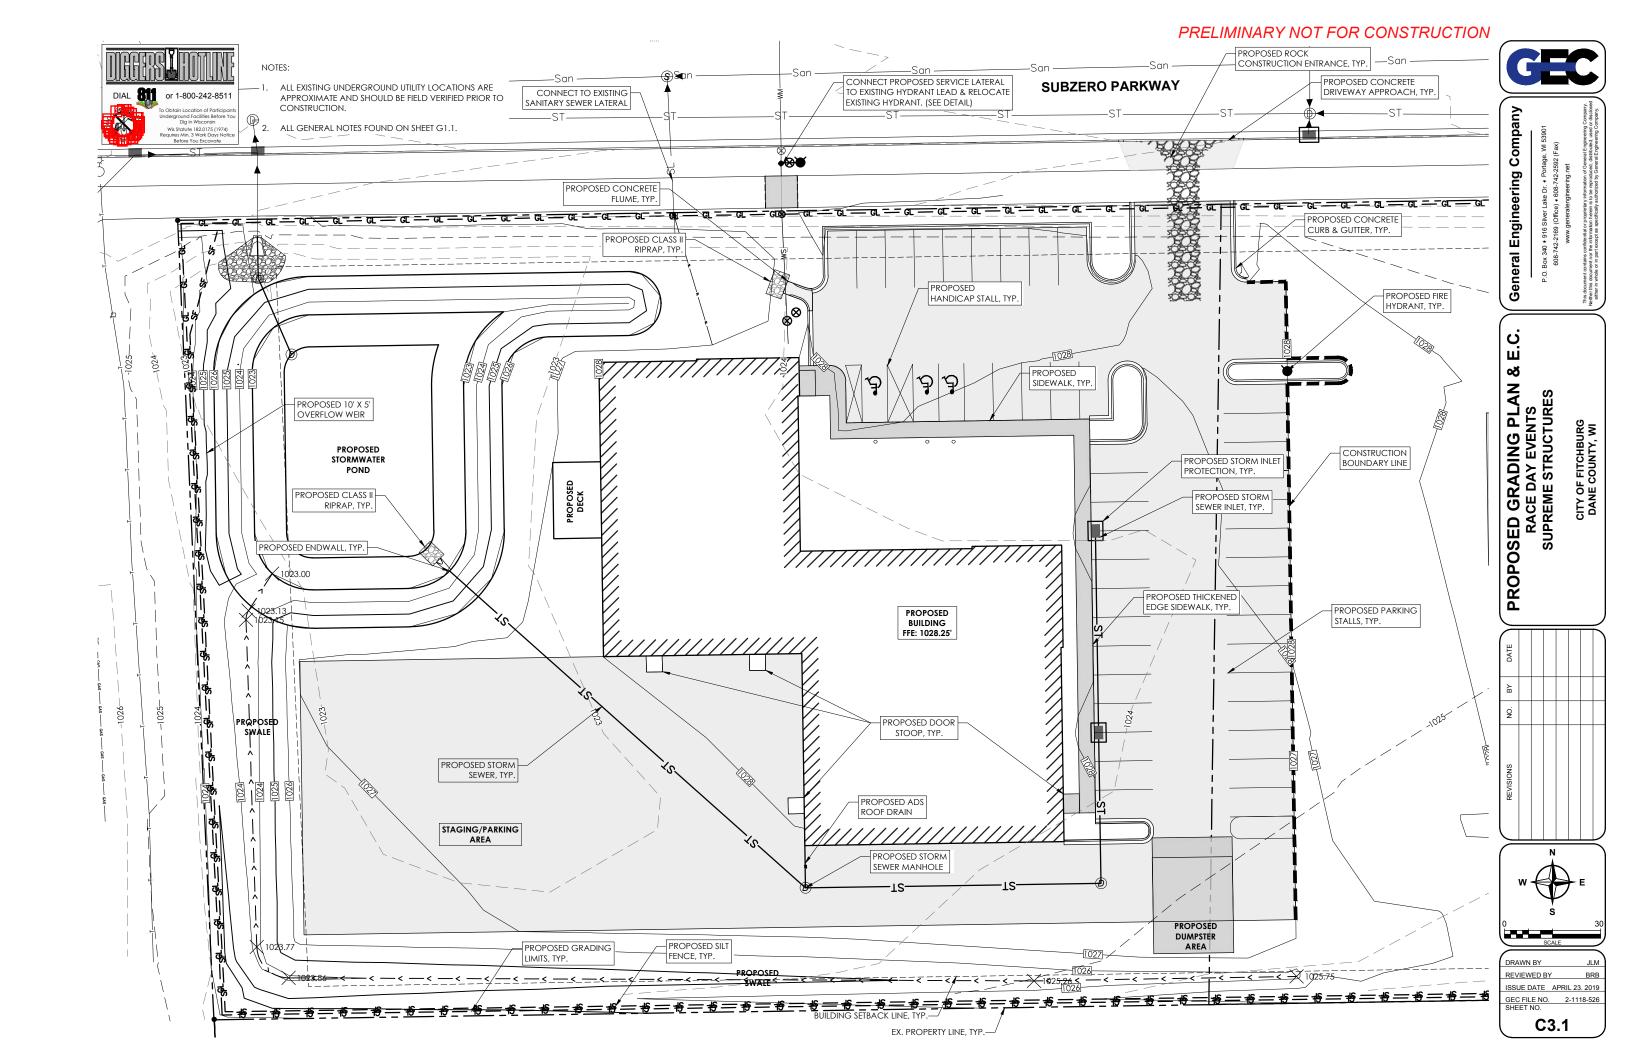
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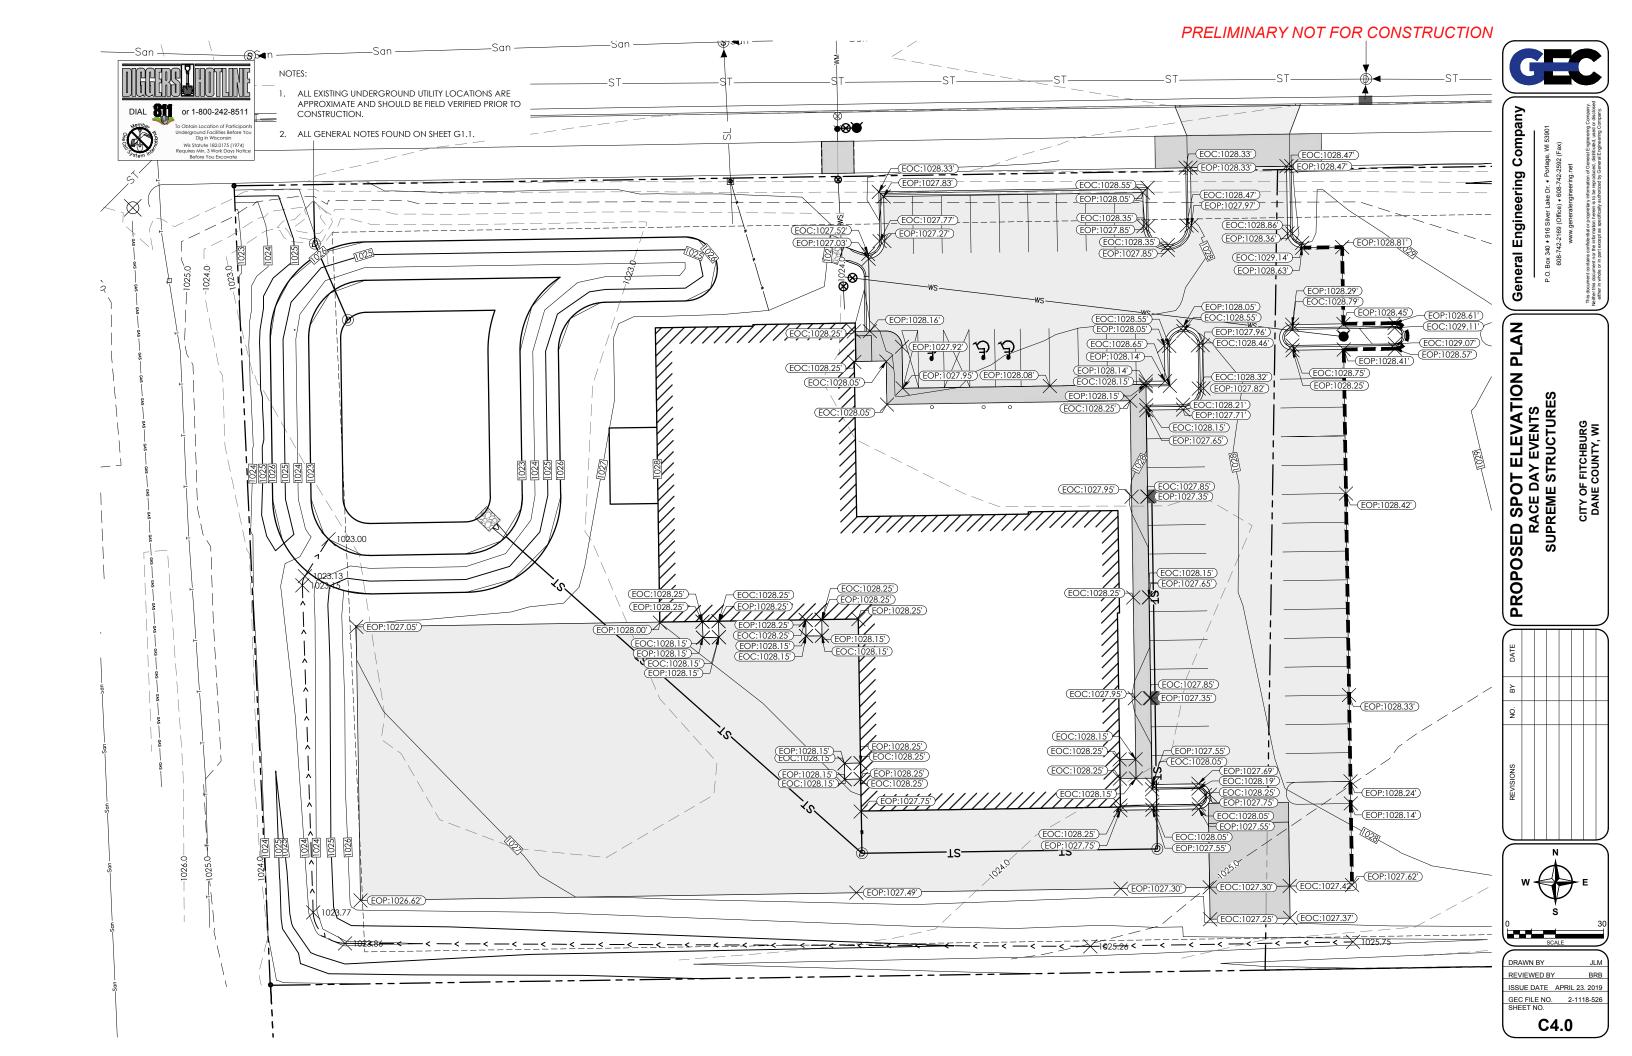










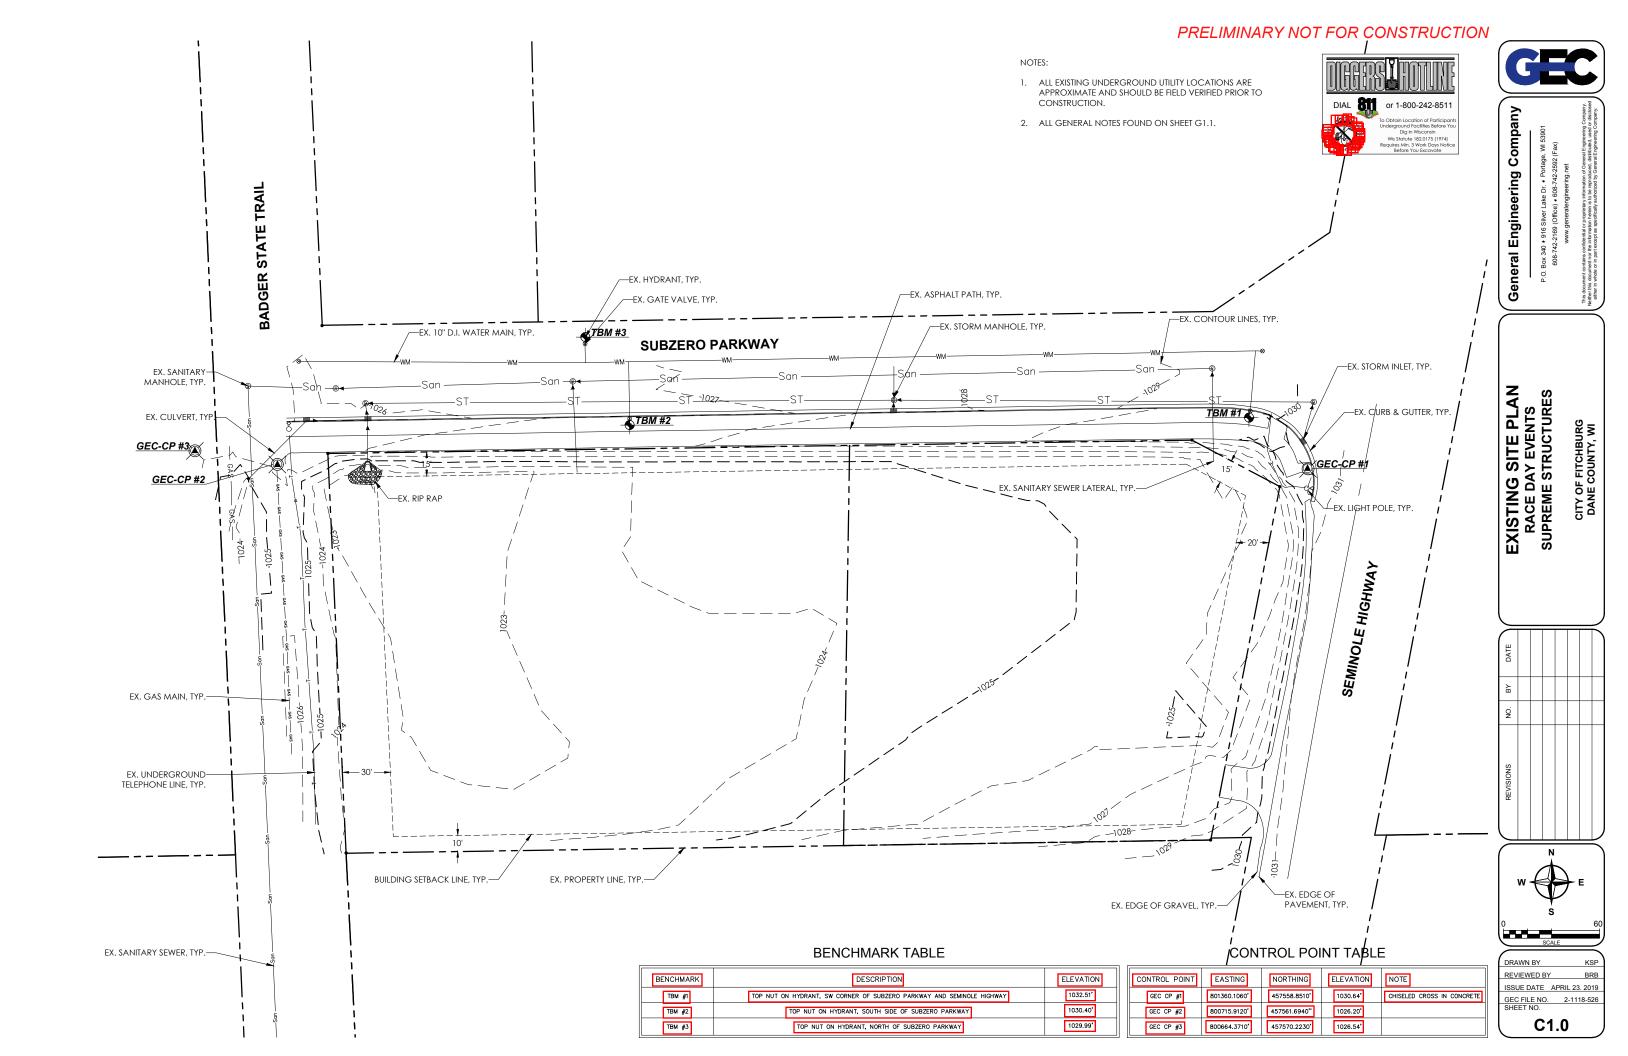

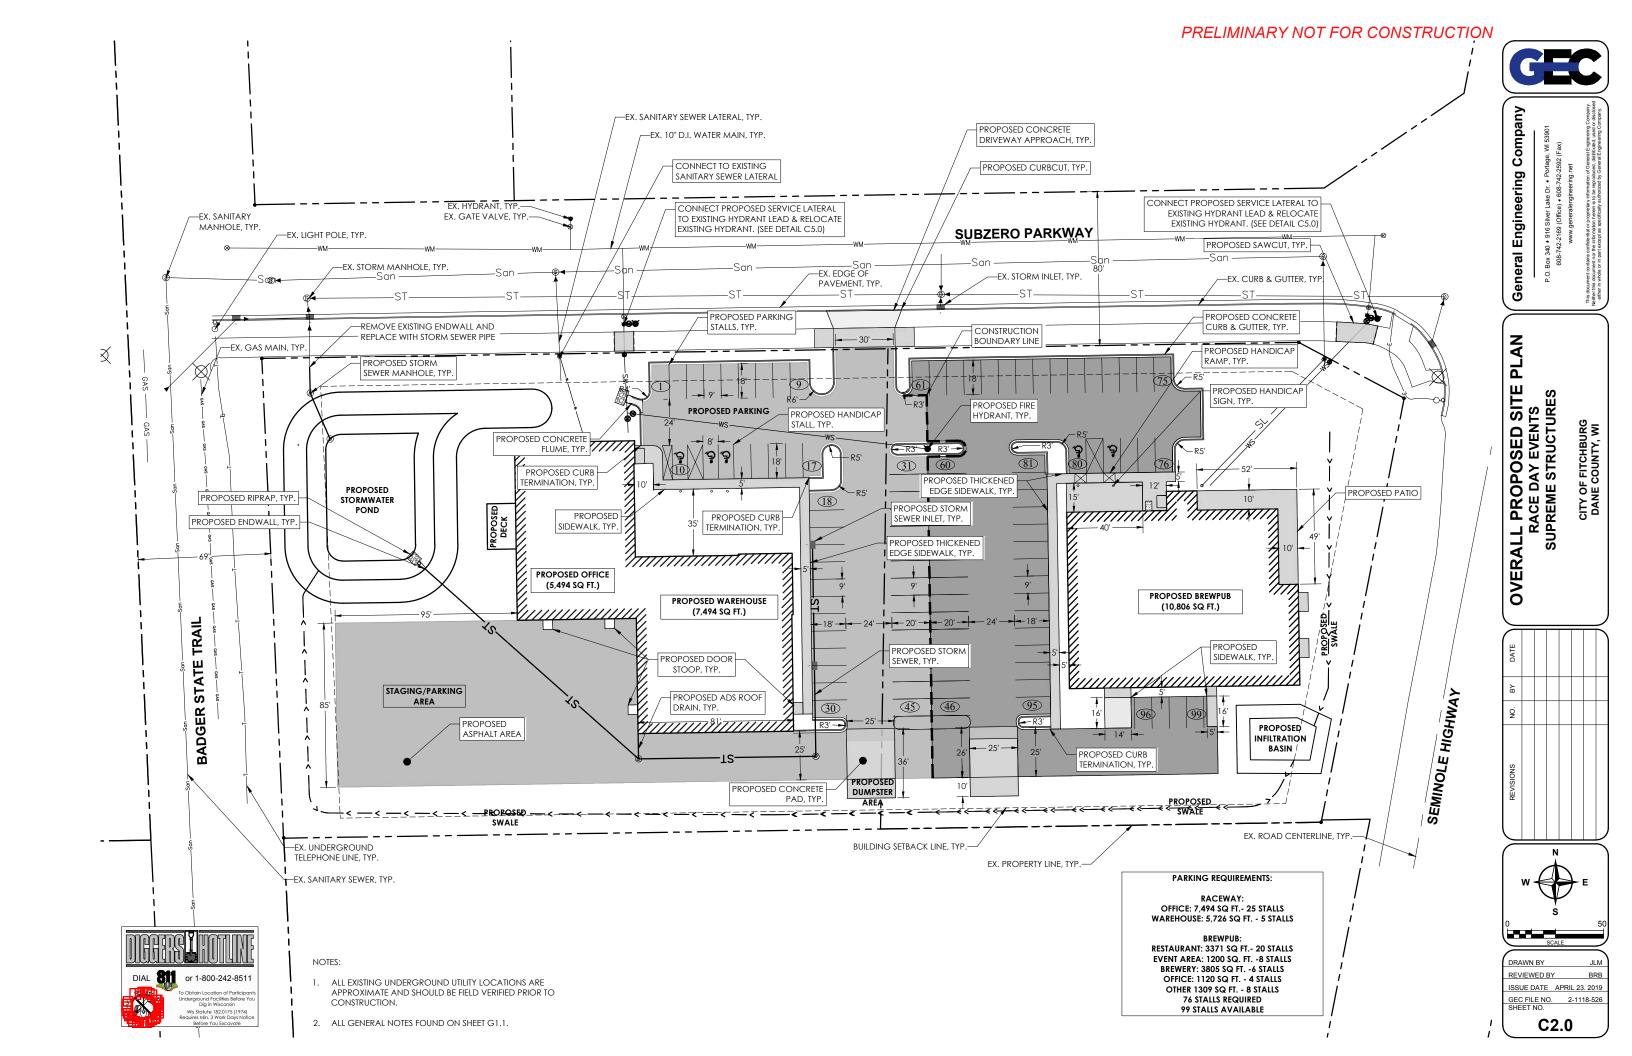

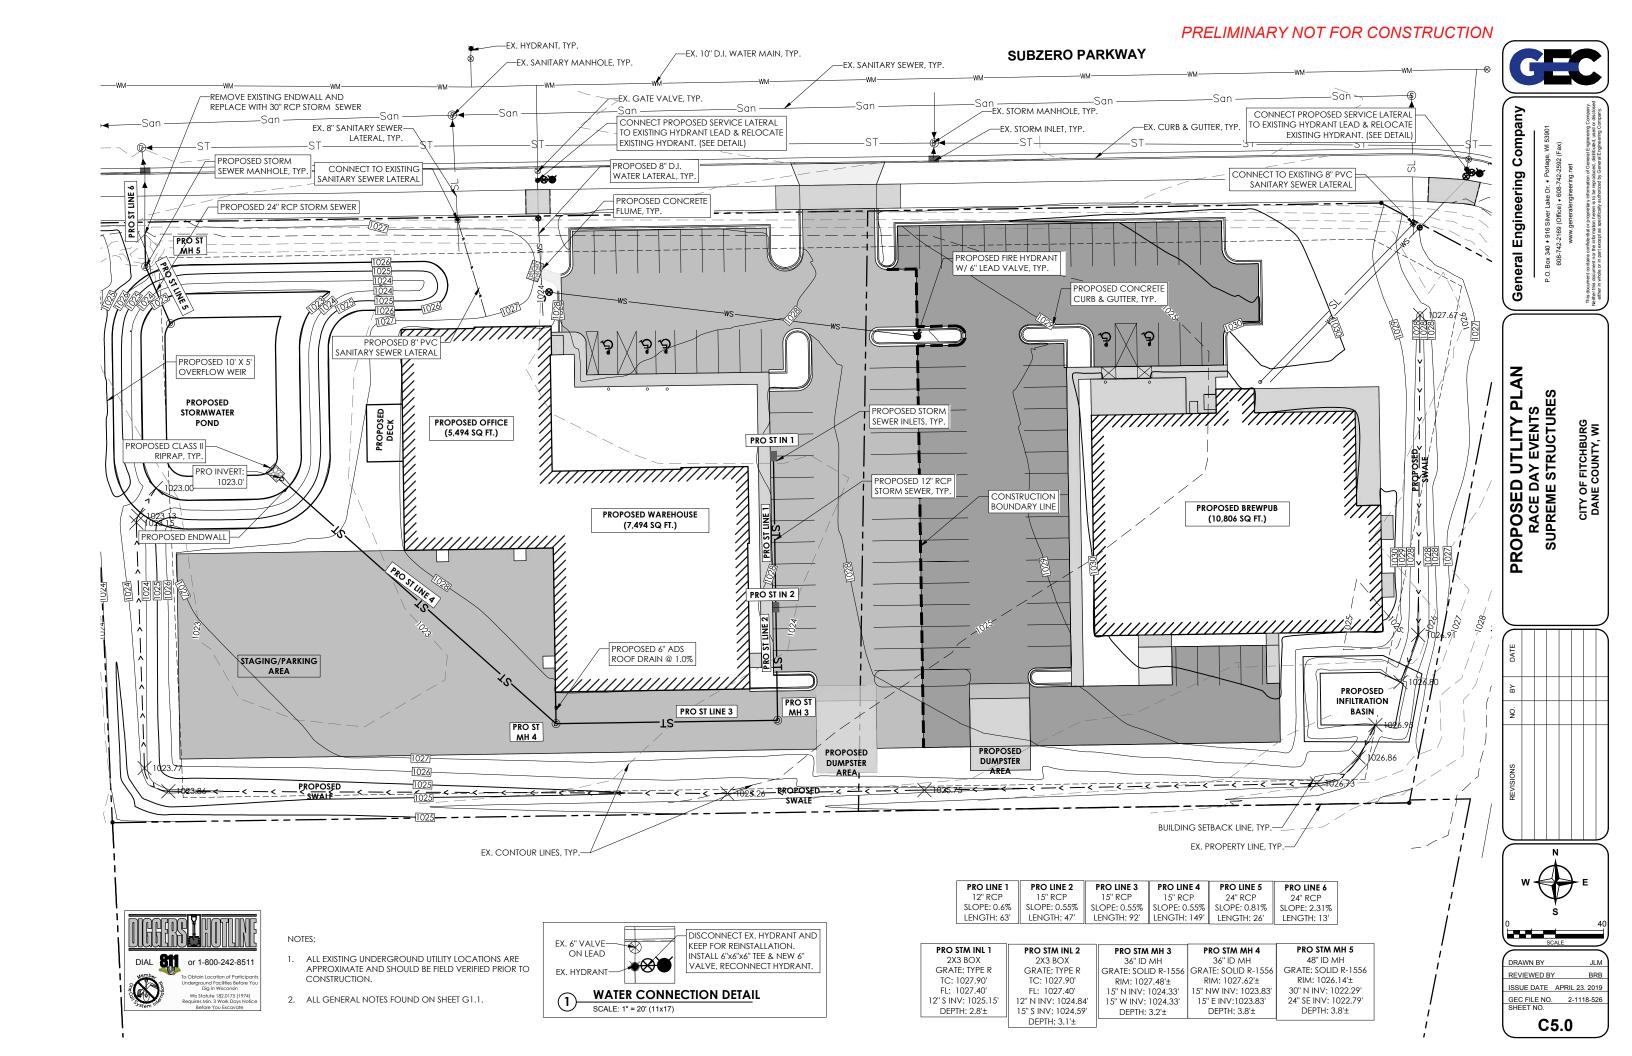

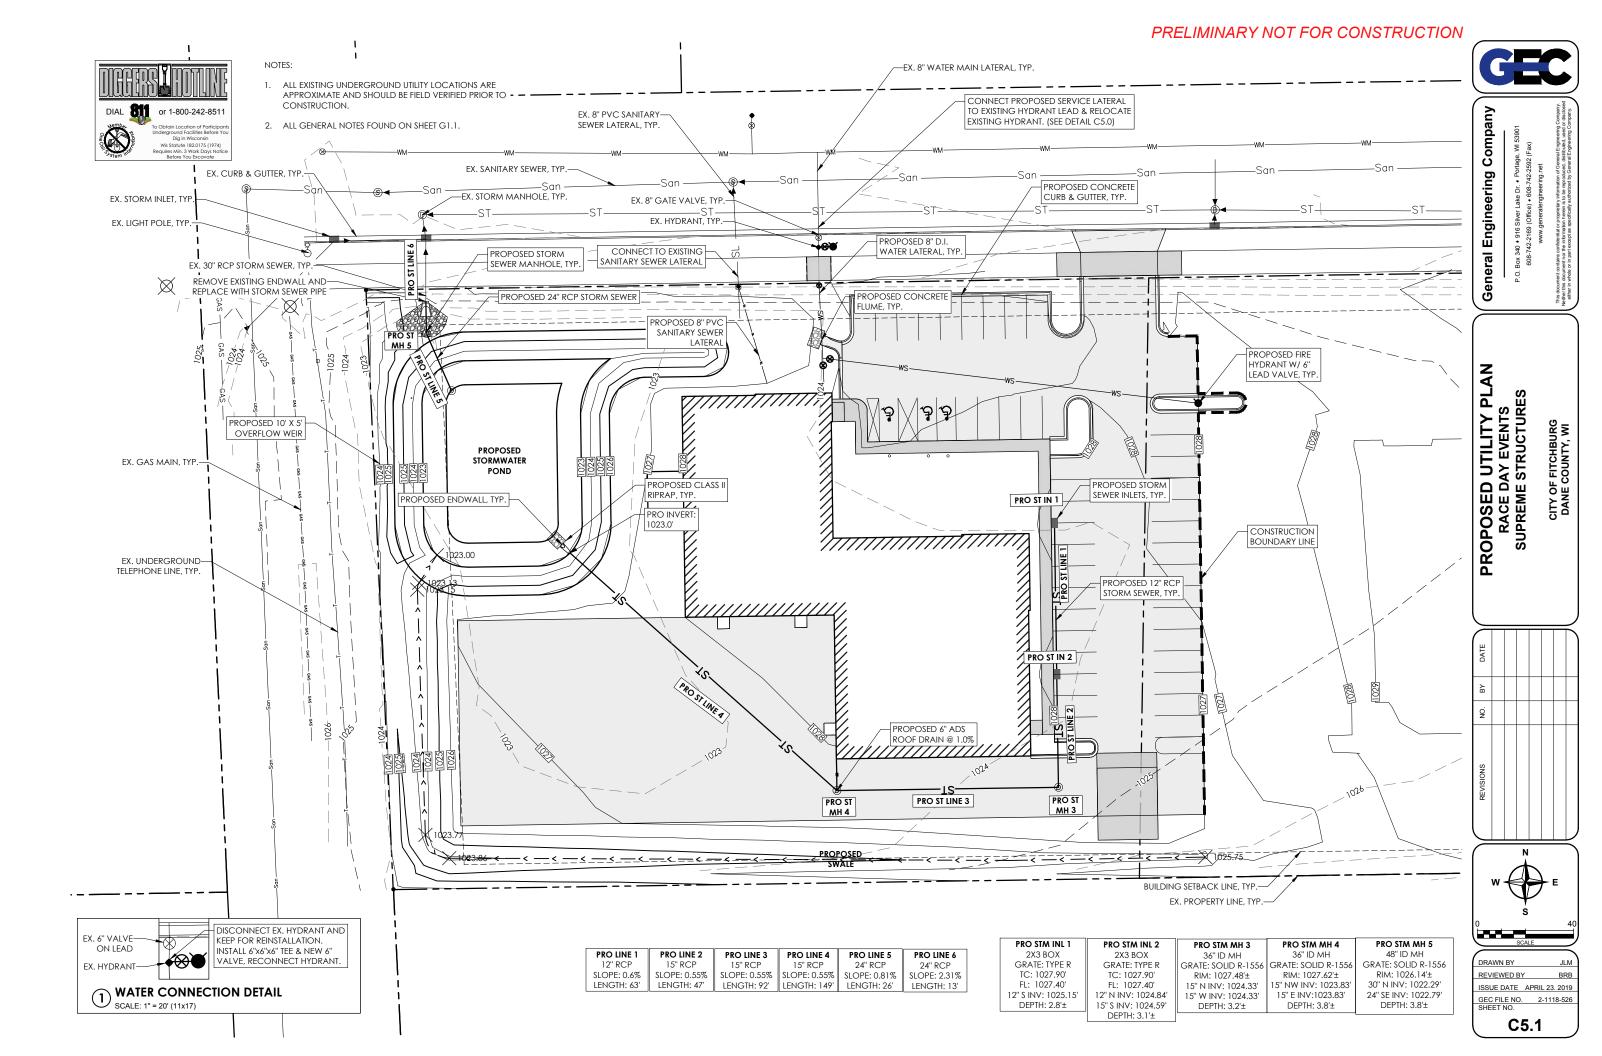

1.01 SECTION INCLUDES

- A. FURNISHING, INSTALLING, MAINTAINING, AND REMOVING EROSION AND SEDIMENT CONTROL FACILITIES AND
- B. THE CONTRACTOR IS RESPONSIBLE FOR PROVIDING ALL EROSION CONTROL FACILITIES AND MEASURES NECESSARY TO CONTROL EROSION AND SEDIMENTATION AT THE WORK SITE. THESE FACILITIES AND MEASURES MAY OR MAY NOT BE SHOWN ON THE DRAWINGS AND THEIR ABSENCE ON THE DRAWINGS DOES NOT ALLEVIATE THE CONTRACTOR FROM PROVIDING THEM. ANY MEASURES AND FACILITIES SHOWN ON THE DRAWINGS ARE THE MINIMUM ACTIONS REQUIRED.

1.02 REFERENCES

- A. WDNR TECHNICAL STANDARDS SEE DNR WEBSITE @ http://dnr.state.wi.us/org/water/wm/nps/stormwater/techstds.htm
- WISCONSIN DEPARTMENT OF TRANSPORTATION, EROSION CONTROL, PRODUCT ACCEPTABILITY LISTS FOR MULTI-MODAL APPLICATIONS PAL, CURRENT EDITION.

- A. REQUIREMENTS OF WDNR TECHNICAL STANDARDS SHALL BE FOLLOWED AT ALL TIMES.
- B. USE SURFACE WATER AND EROSION CONTROL FACILITIES AND MEASURES THROUGHOUT THE DURATION OF THE CONSTRUCTION ACTIVITY TO CONTROL THE MOVEMENT OF SURFACE WATER AND TO REDUCE THE POTENTIAL FOR EROSION. MAINTAIN THE FACILITIES AND MEASURES UNTIL PERMANENT VEGETATION IS ESTABLISHED.
- C. FRODED SOIL MATERIAL SHALL NOT BE ALLOWED TO LEAVE THE CONSTRUCTION SITE OR TO ENTER A WATERWAY, LAKE,
- D. THE CONTRACTOR SHALL BE RESPONSIBLE FOR FURNISHING, INSTALLING, AND MAINTAINING THE EROSION CONTROL FACILITIES, AND IN GENERAL, SHALL USE CONSTRUCTION PRACTICES THAT MINIMIZE EROSION
- E. ERODED MATERIAL THAT HAS LEFT THE CONSTRUCTION SITE SHALL BE COLLECTED AND RETURNED TO THE SITE BY THE
- F. PREVENT CONSTRUCTION SITE TRACKING WITH GRAVELED ROADS, ACCESS DRIVES, AND PARKING AREAS OF SUFFICIENT WIDTH AND LENGTH TO PREVENT SEDIMENT FROM BEING TRACKED ONTO PUBLIC AND PRIVATE ROADWAYS. ANY SEDIMENT REACHING A PUBLIC OR PRIVATE ROAD SHALL BE REMOVED BY STREET CLEANING (NOT FLUSHING) BEFORE

1.04 SEQUENCING AND SCHEDULING

- A. CONSTRUCT AND STABILIZE FROSION CONTROL MEASURES FOR DIVERSIONS OR OUTLIETS PRIOR TO ANY GRADING OR DISTURBANCE OF THE CONSTRUCTION SITE.
- B. INSTALL FILTER FABRIC AND STRAW BALE FENCES AND BARRIERS PRIOR TO DISTURBING THE AREA
- TURF AREAS THAT HAVE BEEN COMPLETED TO FINISH GRADE SHALL BE STABILIZED WITH PERMANENT SEEDING WITHIN SEVEN DAYS. TURF AREAS WHERE ACTIVITY HAS CEASED AND THAT WILL REMAIN EXPOSED FOR MORE THAN 20 DAYS BEFORE ACTIVITY RESUMES AND SOIL STOCKPILES SHALL BE STABILIZED WITH TEMPORARY SEEDING OR SOIL STABILIZER
- D. OTHER EROSION CONTROL MEASURES SHALL BE IN PLACE PRIOR TO DISTURBANCE OF THE CONSTRUCTION SITE, AS

PART 2 - PRODUCTS

2.01 SILT FENCE

FABRIC SHALL BE SHALL A WOVEN OR NONWOVEN POLYESTER, POLYPROPYLENE, STABILIZED NYLON, OR POLYETHYLENE GEOTEXTILE WITH THE FOLLOWING MINIMUM PROPERTIES:

PROPERTY	TEST METHOD	REQUIREMENT*
GRAB TENSILE STRENGTH, LBS MIN.	ASTM D 4632	
MACHINE DIRECTION		120
CROSS DIRECTION		100
MAX. APPARENT OPENING SIZE,		
US SIEVE	ASTM D 4751	NO. 30
PERMITTIVITY, SEC-1, MIN.	ASTM D 4491	0.05
MIN. UV STABILITY AT 500 HRS, %	ASTM D 4355	70%

* MINIMUM OR MAXIMUM AVERAGE ROLL VALUES.

- A. STRAW OR HAY BALES IN GOOD CONDITION WITH NOMINAL DIMENSIONS OF 14" W x 18"H x 30"L.
- B. STAKES: WOOD STAKES WITH MINIMUM DIMENSION OF 2" x 2" x 30".

2.03 SEDIMENT LOGS

- A. WOOD EXCELSIOR LOG WRAPPED IN BIODEGRADABLE FABRIC OR MESH AND LISTED IN THE EROSION CONTROL PRODUCT ACCEPTABILITY LISTS.
- B. STAKES: WOOD STAKES WITH MINIMUM DIMENSION OF 1" x 1" x 24"

A. AREAS NEEDING PROTECTION DURING PERIODS WHEN PERMANENT SEEDING IS NOT APPLIED SHALL BE SEEDED WITH ANNUAL SPECIES FOR TEMPORARY PROTECTION. PROVIDE SPECIES AS FOLLOWS

SPECIES	% PURITY
OATS	98
CEREAL RYE	97
WINTER WHEAT	95
ANNUAL RYFGRASS	97

B. PROVIDE OATS FOR SPRING AND SUMMER. PROVIDE CEREAL RYE, WINTER WHEAT, OR ANNUAL RYEGRASS FOR FALL

2.05 EROSION MAT

- A. ALL EROSION MAT PRODUCTS SHALL BE OF THE CLASS AND TYPE INDICATED AND SHALL BE CHOSEN FROM THE EROSION CONTROL PRODUCT ACCEPTABILITY LISTS
- B. CLASS I: A SHORT-TERM DURATION (SIX MONTHS OR GREATER), LIGHT DUTY, ORGANIC MAT. NETTING SHALL BE ORGANIC, PHOTODEGRADABLE PLASTIC OR BIODEGRADABLE NETTING. THE WEIGHT OF THE NETTING SHALL NOT EXCEED 15% OF THE TOTAL BLANKET WEIGHT. THE NETTING SHALL BE SUFFICIENTLY BONDED TO THE PARENT MATERIAL TO PREVENT SEPARATION FOR THE LIFE OF THE PRODUCT.
 - TYPE A: A NETTED PRODUCT FOR USE ON SLOPES 2.5 TO 1 OR FLATTER WITH A MINIMUM PRODUCT PERMISSIBLE SHEAR STRESS OF 50 PA (1.0 LBS/FT2). NOT TO BE USED IN CHANNELS.
 - TYPE B: A DOUBLE NETTED PRODUCT FOR USE ON SLOPES 2 TO 1 OR FLATTER OR IN CHANNELS WITH A MINIMUM PRODUCT PERMISSIBLE SHEAR STRESS OF 70 PA (1.5 LBS/FT2).
- C. CLASS II: A LONG-TERM DURATION (3 YEARS OR GREATER), ORGANIC MAT. THE WEIGHT OF THE NETTING SHALL NOT EXCEED 15% OF THE TOTAL BLANKET WEIGHT. THE NETTING SHALL BE BONDED SUFFICIENTLY TO THE PARENT MATERIAL TO PREVENT SEPARATION OF THE NET FROM THE PARENT MATERIAL FOR THE LIFE OF THE PRODUCT
 - TYPE A: JUTE FIBER ONLY TO BE USED FOR REINFORCING SOD.
- TYPE B: FOR USE ON SLOPES 2:1 OR FLATTER, OR IN CHANNELS WITH A MINIMUM PRODUCT PERMISSIBLE SHEAR STRESS OF 95 PA (2.0 LBS/F12). NON-ORGANIC, PHOTODEGRADABLE, OR BIODEGRADABLE NETTING ALLOWED.
- TYPE C: FOR USE ON SLOPES 2:1 OR FLATTER, OR IN CHANNELS WITH A MINIMUM PRODUCT PERMISSIBLE SHEAR STRESS OF 95 PA (2.0 LBS/FT2). ONLY 100% ORGANIC FIBERS ALLOWED. WOVEN MATS ARE ALLOWED WITH A MAXIMUM OPENING OF ½ INCH. USE IN ENVIRONMENTALLY SENSITIVE AREAS THAT HAVE A HIGH PROBABILITY OF ENTRAPPING ANIMALS IN THE PLASTIC NETTING.
- D. STAPLES: U-SHAPED NO. 11 GAUGE OR GREATER WIRE WITH A SPAN WIDTH OF ONE TO TWO INCHES AND A LENGTH OF NOT LESS THAN 6 INCHES FOR FIRM SOIL AND 12 INCHES FOR LOOSE SOIL

- A. SOIL STABILIZER SHALL BE A POLYACRYLAMIDE (PAM) AND CALCIUM SOLUTION INTENDED TO REDUCE THE ERODIBILITY OF BARE SOILS. THE PRODUCT SHALL ACHIEVE AN 80% REDUCTION IN SOIL LOSS INDUCED BY A TWO INCH PER HOUR RAINFALL SIMULATOR
- B. PAM MIXTURES SHALL BE ENVIRONMENTALLY BENIGN. HARMLESS TO FISH, AQUATIC ORGANISMS, WILDLIFE, AND PLANTS, ONLY ANIONIC PAM WILL BE PERMITTED.
- ANIONIC PAM, IN PURE FORM SHALL HAVE NO MORE THAN 0.05% FREE ACRYLIC MONOMER BY WEIGHT, AS ESTABLISHED BY THE FOOD AND DRUG ADMINISTRATION AND THE ENVIRONMENTAL PROTECTION AGENCY. THE ANIONIC PAM IN PURE FORM SHALL NOT EXCEED 200 POUNDS PER BATCH.
- D. THE PRODUCT PROVIDED SHALL BE LISTED IN THE WISDOT PAL FOR TYPE B SOIL STABILIZER.

- A. TYPE A: USE AROUND FIELD INLETS UNTIL PERMANENT STABILIZATION METHODS HAVE BEEN ESTABLISHED. USE ON AVEMENT INLETS PRIOR TO INSTALLATION OF CURB AND GUTTER OR PAVEMENT.
- B. TYPE B: USE ON INLETS WITHOUT CURB HEAD AFTER CASTING AND GRATE ARE IN PLACE.
- TYPE D: USE IN AREAS WHERE OTHER TYPED OF INLET PROTECTION ARE INCOMPATIBLE WITH ROADWAY AND TRAFFIC CONDITIONS CAUSING POSSIBLE SAFETY HAZARDS WHEN PONDING OCCURS AT INLET.
- E. GEOTEXTILE: TYPE FF MEETING THE REQUIREMENTS OF THE LATEST EDITION OF WISDOT PAL.

PART 3 - EXECUTION

A. TEMPORARY DIVERSIONS SHALL BE DESIGNED AND INSTALLED IN ACCORDANCE WITH WDNR CONSERVATION PRACTICE STANDARD, CONSTRUCTION SITE DIVERSION (1066)

3.02 INSTALLATION OF SILT FENCE AND STRAW BALE BARRIERS

- A. INSTALL STRAW BALE BARRIERS IN ACCORDANCE WITH THE DRAWINGS AND WDNR CONSERVATION PRACTICE STANDARD, SEDIMENT BALE BARRIER (1055).
- B. INSTALL SILT FENCE IN ACCORDANCE WITH THE DRAWINGS AND WDNR CONSERVATION PRACTICE STANDARD, SILT FENCE (1056)
- C. SILT FENCE AND STRAW BALE BARRIERS SHALL BE PLACED ON THE CONTOUR TO THE EXTENT PRACTICABLE. PLACE FENCES PARALLEL TO THE SLOPE WITH THE ENDS OF THE FENCE TURNED UPSLOPE A DISTANCE OF ONE TO TWO FEET. THE PARALLEL SPACING SHALL NOT EXCEED THE MAXIMUM SLOPE LENGTHS AS INDICATED IN THE FOLLOWING TABLE:

FENCE AND BARRIER SPACING		
SLOPE	SPACING	
<2%	100'	
2 - 5%	75'	
5 - 10%	50'	
10 - 33%	25'	
>33%	20'	

3.03 TEMPORARY SEEDING

- A. PROVIDE A SEEDBED OF LOOSE SOIL TO A MINIMUM DEPTH OF 2 INCHES.
- APPLY SEED EVENLY AT THE RATE SHOWN IN THE FOLLOWING TABLE. RAKE OR DRAG TO COVER THE SEED TO A DEPTH

SPECIES	LBS./ACRE
OATS	131
CEREAL RYE	131
WINTER WHEAT	131
ANNUAL RYEGRASS	80

3.04 EROSION MAT INSTALLATION

- A. REMOVE STONES, CLODS, STICKS, OR OTHER FOREIGN MATERIAL THAT WOULD DAMAGE THE MAT OR INTERFERE WITH THE MAT BEARING COMPLETELY ON THE SURFACE.
- B. INSTALL EROSION MAT IN ACCORDANCE WITH THE MANUFACTURER'S RECOMMENDATIONS
- C. AFTER SEEDING HAS BEEN COMPLETED, ROLL BLANKETS OUT PARALLEL TO THE DIRECTION OF WATER FLOW, WITH THE NETTING ON TOP. SPREAD THE BLANKETS WITHOUT STRETCHING, MAKING SURE THE FIBERS ARE IN CONTACT WITH THE SOIL. OVERLAP ADJACENT STRIPS IN ACCORDANCE WITH THE MANUFACTURER'S RECOMMENDATIONS. OVERLAP STRIP ENDS A MINIMUM OF 10 INCHES WITH THE UPGRADE STRIP ON TOP. BURY THE UPGRADE END OF EACH STRIP IN A VERTICAL TRENCH AT LEAST 6 INCHES DEEP.
- D. STAPLE THE MAT STRIPS IN ACCORDANCE WITH THE MANUFACTURER'S RECOMMENDATIONS. STAPLE LONGITUDINAL OVERLAPS AND OUTER EDGES AT MAXIMUM INTERVALS OF 3 FEET. STAPLE STRIP ENDS AT MAXIMUM INTERVALS OF 16 INCHES. PLACE STAPLES THROUGHOUT THE MAT AT MAXIMUM 3-FOOT INTERVALS. INSERT STAPLES FLUSH WITH THE GROUND SURFACE.

3.05 SOIL STABILIZER

- A. THE MANUFACTURER SHALL PROVIDE DETAILED WRITTEN INSTRUCTIONS ON THE STORAGE, MIXING, AND APPLICATION
- B. THE SOIL STABILIZER MAY BE APPLIED BY SPRAYING OR BY DRY SPREADING.
- C. APPLICATION RATES: APPLY AT THE RATE RECOMMENDED BY THE MANUFACTURER
- D. DO NOT APPLY WITHIN 30 FEET OF BODY OF WATER (I.E. LAKE, RIVER, STORMWATER POND).

3.06 DITCH EROSION CONTROL

A. THE FOLLOWING EROSION CONTROL MEASURES ARE MINIMUM REQUIREMENTS FOR ALL DITCHES, THE DRAWINGS MAY INCLUDE MORE SPECIFIC MEASURES.

DITCH EROSION CONTROL				
SLOPE	METHOD	BALE CHECKS		
RANGE				
0 - 1%	SEED AND MULCH	NONE		
1% - 4% SEED AND MULCH WITH EROSION MAT		1% - 2%; EVERY 200'		
		2% - 4%; EVERY100'		
4% - 6%	STAKED SOD	EVERY 75'		
>6%	STAKED SOD AND/OR RIPRAP AS			
	SPECIFIED BY ENGINEER ON DRAWINGS	EVERY 75' FOR SOD		

B. STONE DITCH CHECKS: LINESS OTHERWISE INDICATED ON THE DRAWINGS, INSTALL STONE DITCH CHECKS AT INTERVALS. OF ONE DITCH CHECK FOR EVERY TWO FEET OF DROP IN CHANNEL GRADE

3.07 INSTALLATION OF SOD IN DITCHES

- A. LAY SOD SO THAT JOINTS OF ABUTTING ENDS OF STRIPS ARE NOT CONTINUOUS. LAY EACH STRIP SNUGLY AGAINST PREVIOUSLY LAID STRIPS
- B. ROLL OR FIRMLY TAMP SOD TO PRESS THE SOD INTO THE UNDERLYING SOIL
- C. TURN THE UPPER EDGES OF THE STRIPS INTO THE SOIL
- D. STAKE STRIPS ALONG THE LONGITUDINAL AXIS AT 18-INCH INTERVALS AND NEAR THE TOP EDGE OF THE STRIP. PROVIDE WOOD LATH OR SIMILAR STAKES, 12 INCHES LONG. LEAVE TOP OF STAKE APPROXIMATELY 1/2 INCH ABOVE SOD.

3.08 INSTALLATION OF OTHER FACILITIES

A. INLET PROTECTION BARRIERS, CHANNEL STABILIZATION, GRASSED WATERWAYS, ROCK LINED WATERWAYS, SEDIMENTS TRAPS, SEDIMENT BASINS, AND OTHER FORMS OF FROSION CONTROL MEASURES SHALL BE DESIGNED AND INSTALLED IN ACCORDANCE WITH WDNR TECHNICAL STANDARDS.

- A. INSPECT DIVERSIONS WITHIN 24 HOURS AFTER EACH RAINFALL OR DAILY DURING PERIODS OF PROLONGED RAINFALL, UNTIL THE VEGETATIVE COVER IS STABILIZED. MAKE NECESSARY REPAIRS IMMEDIATELY
- INSPECT FILTER FABRIC FENCES AND BARRIERS WITHIN 24 HOURS AFTER EACH RAINFALL OR DAILY DURING PERIODS OF PROLONGED RAINFALL. NECESSARY REPAIRS OR REPLACEMENT SHALL BE MADE. IMMEDIATELY. REMOVE SEDIMENT DEPOSITS WHEN DEPOSITS REACH ONE-HALF THE HEIGHT OF THE FENCE. FOLLOW MANUFACTURER'S OMMENDATIONS FOR REPLACING FABRIC DUE TO WEATHERING
- C. INSPECT STRAW BALE FENCES AND BARRIERS WITHIN 24 HOURS AFTER EACH RAINFALL OR DAILY DURING PERIODS OF PROLONGED RAINFALL. NECESSARY REPAIRS OR REPLACEMENT SHALL BE MADE IMMEDIATELY, REMOVE SEDIMENT DEPOSITS WHEN DEPOSITS REACH ONE-THIRD THE HEIGHT OF THE BALES. REPLACE BALES AFTER THREE MONTHS.
- D. INSPECT ALL SEEDING, SOD, MULCHES, MATS AND NETS WITHIN 24 HOURS AFTER EACH RAINFALL OR DAILY DURING PERIODS OF PROLONGED RAINFALL. ADDITIONAL MULCH, NETTING OR MATTING SHALL BE APPLIED IMMEDIATELY WHEN NECESSARY TO MAINTAIN SUITABLE COVERAGE. MAKE INSPECTIONS UNTIL VEGETATIVE COVER IS ESTABLISHED. WATER SEEDING AND SOD WHEN NECESSARY TO PROMOTE ESTABLISHMENT.
- E. ALL OTHER SOIL EROSION CONTROL MEASURES SHOULD BE INSPECTED AND REPAIRED IMMEDIATELY, IF REQUIRED, WITHIN 24 HOURS AFTER STORM EVENT OR DAILY DURING PERIODS OF PROLONGED RAINFALL.

AFTER FINAL VEGETATION IS ESTABLISHED, REMOVE BALES, SILT FENCES, DITCH CHECKS, DIVERSIONS, AND OTHER EROSION CONTROL FACILITIES. RESTORE AREAS DISTURBED BY THE REMOVALS.

- A. UNI ESS INDICATED OTHERWISE WITHIN THE CONTRACT DOCUMENTS. THE CONTRACTOR SHALL BE RESPONSIBLE FOR THE MONITORING REQUIREMENTS OF THE WPDES PERMIT FOR STORM WATER DISCHARGES ASSOCIATED WIT CONSTRUCTION ACTIVITIES.
- B. EROSION AND SEDIMENT CONTROLS SHALL BE ROUTINELY INSPECTED AT LEAST EVERY SEVEN DAYS, AND WITHIN 24 HOURS AFTER A PRECIPITATION EVENT OF 0.5 INCHES OR GREATER. WEEKLY WRITTEN REPORTS OF ALL INSPECTIONS SHALL BE MAINTAINED AND SUBMITTED TO THE ENGINEER. THE REPORTS SHALL CONTAIN THE FOLLOWING INFORMATION:
- DATE, TIME, AND EXACT PLACE OF INSPECTION
- NAME(S) OF INDIVIDUAL(S) PERFORMING INSPECTION
- AN ASSESSMENT OF THE CONDITION OF EROSION AND SEDIMENT CONTROLS.

 A DESCRIPTION OF ANY EROSION AND SEDIMENT CONTROL IMPLEMENTATION AND
- MAINTENANCE PERFORMED
- A DESCRIPTION OF THE SITES PRESENT PHASE OF CONSTRUCTION.
- C. THE ENGINEER WILL PROVIDE THE CONTRACTOR WITH THE APPROPRIATE DNR FORM TO USE FOR THE INSPECTIONS

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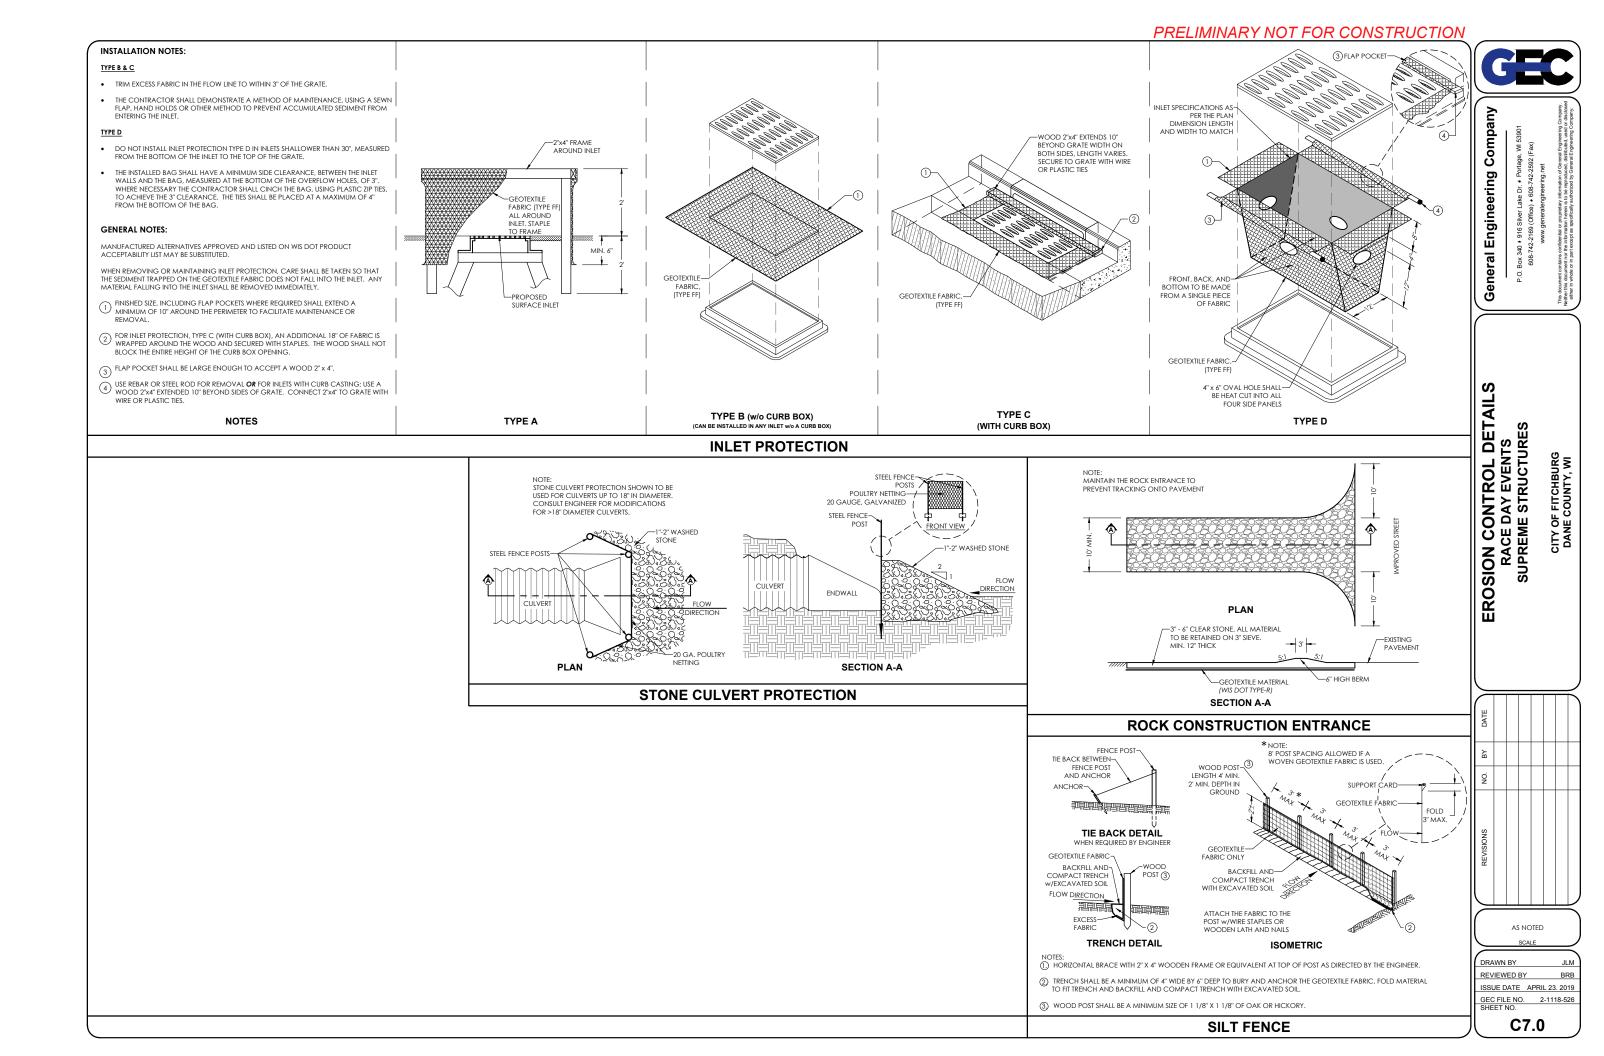
ഗ CIFICATION CONTROL SPECIF RACE DAY EVENTS SUPREME STRUCTURE CITY OF FITCHBURG DANE COUNTY, WI


AS NOTED

REVIEWED BY ISSUE DATE APRIL 23. 2019 GEC FILE NO. 2-1118-526 SHEET NO.

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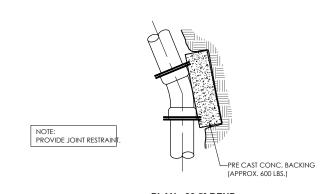




CONCRETE BACKING

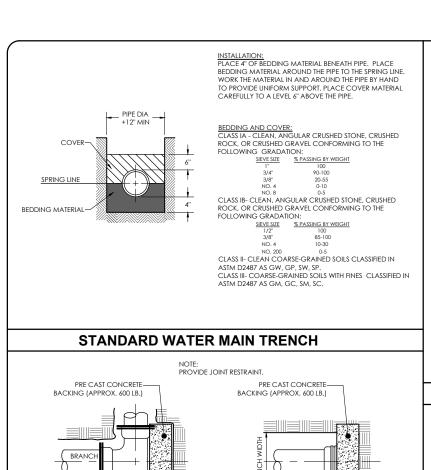
CAP ON SPIGOT END, PLUG ON

PLAN - @ DEAD ENDS




PLAN - @ TEES


PLAN - 22.5° BEND

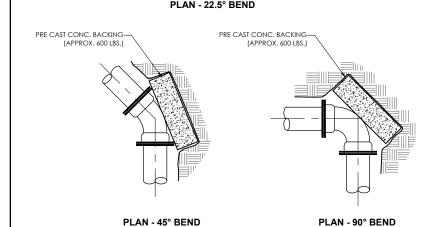


CONCRETE BACKING FOR BENDS

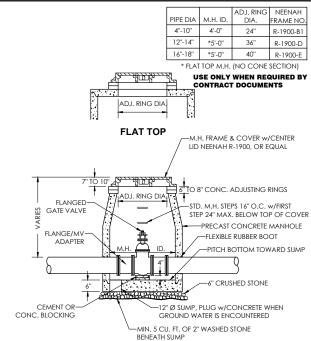


STANDARD VAULT FOR GATE VALVES

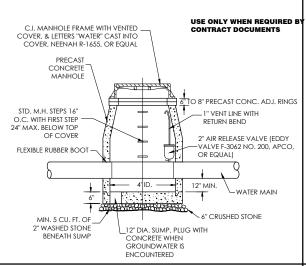

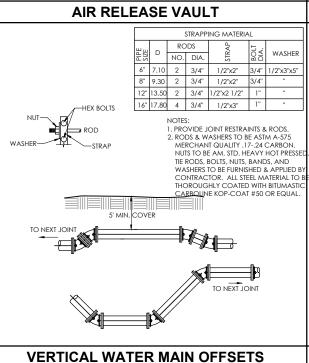

* A 2" TAP ON A 6" DIAMETER MAIN REQUIRES A DOUBLE

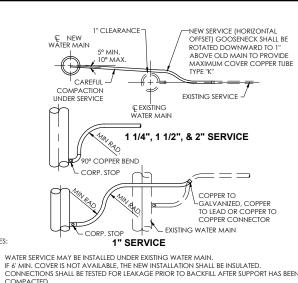

- COMPACTED


TAP SERVICE PIPING

PIPE SIZE MIN. RADII ARE AS FOLLOWS:

NOTES:

1"=6", $1\frac{1}{4}$ "=8", $1\frac{1}{2}$ "=10", 2"=12" 5. TAP AND SERVICE SHALL BE SAME SIZE AS EXISTING w/MIN. OF 1"

PRELIMINARY NOT FOR CONSTRUCTION

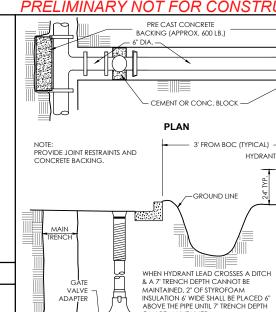

- BEDDING MATERIAL

PAVED AREA

WATER MAIN

NO JOINTS PERMITTED WITHIN THE BORE.

PRE CAST CONCRETE

BACKING (APPROX, 600 LB.)

CAN BE MAINTAINED.

ELEVATION

STANDARD HYDRANT SETTING

PLACE BEDDING BEFORE PUSHING PIPE. BACKFILL BETWEEN WATER MAIN AND BORED HOLE BY PUMPING OR BLOWING IN SAND.

BORING WITHOUT CASING PIPE


PRE CAST CONCRETE BACKING

CASING

WOOD BLOCKING

IS NOT ALLOWED

FRONT VIEW

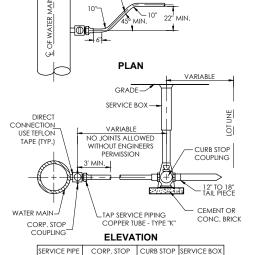

-CEMENT OR CONC. BLOCKING

STANDARD GATE VALVE BOX SETTING


SIDE VIEW

-BOX TOP

VALVE

COUPLING ELEVATION				
	SERVICE PIPE	CORP. STOP	CURB STOP	SERVICE BOX
	1"	1"	1"	2 1/2"
	1 1/4" 1 1/4"		1 1/4"	3"
	1 1/2"	1 1/4" x 1 1/2"	1 1/2"	3"
	* 2"	1 1/2" x 2"	2"	3"

TAP SERVICE PIPING (COPPER)

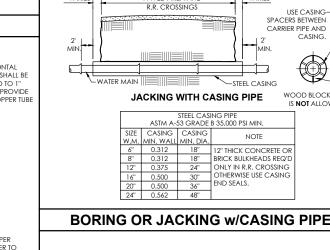

BORING OR JACKING W/CASING PIPE

- SERVICE TAPS IN ALL WATER MAIN PIPE SHALL BE MADE WITH 2 WRAPS OF 3 MIL. TEFLON TAPE ON CORPORATION STOP THREADS, WHEN MORE THAN ONE TAP IN THE MAIN IS NECESSARY TO DELIVER THE
- REQUIRED FLOW FOR SERVICE LINES. THEY SHOULD BE STAGGERED AROUND THE CIRCUMFERENCE A MINIMUM OF 12" APART.



Company General Engineering

S ETAIL

FRUCTION | MAIN CONSTRUCTION RACE DAY EVENTS SUPREME STRUCTURES WATER


CITY OF FITCHBURG DANE COUNTY, WI

AS NOTED

DRAWN BY REVIEWED BY ISSUE DATE APRIL 23. 2019 GEC FILE NO. 2-1118-526 SHEET NO.

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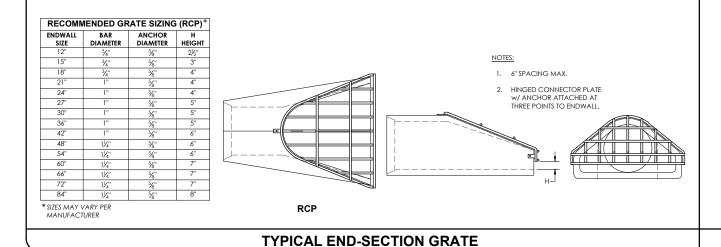
GENERAL NOTES

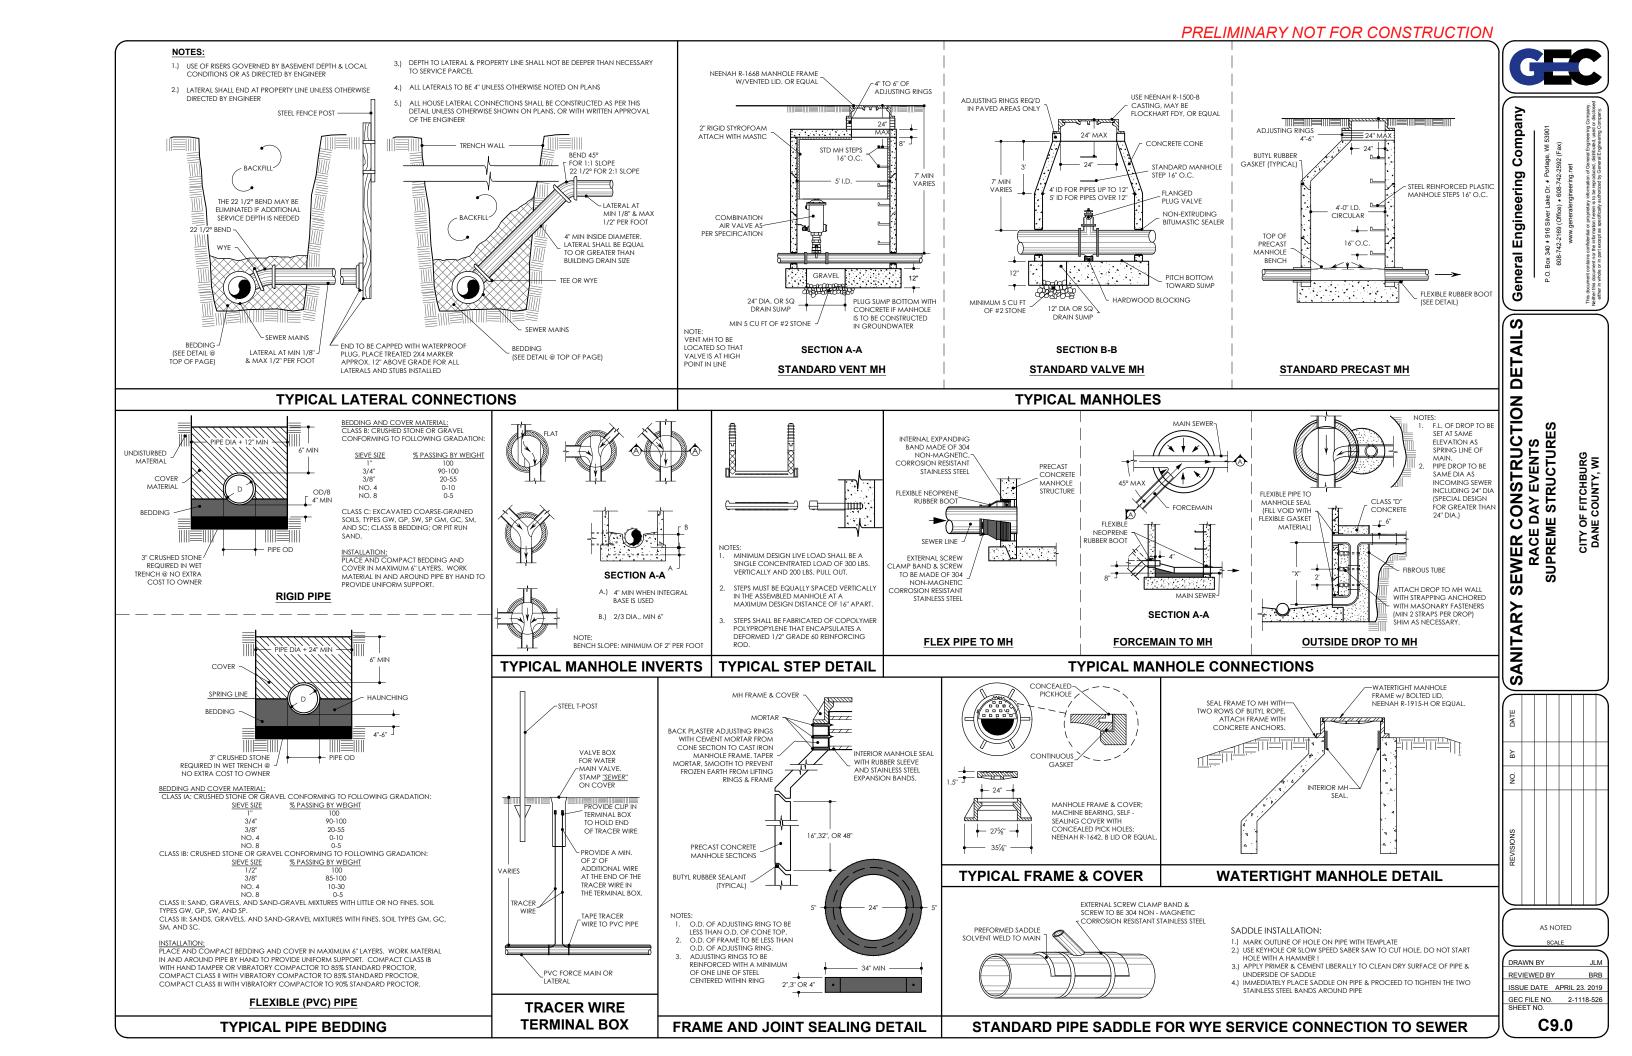


- . CONTRACTOR SHALL CONSTRUCT TOP OF INFILTRATION BASIN 0.5' HIGHER THAN DESIGN ELEVATIONS TO ALLOW FOR SETTLEMENT.
- 2. INFILTRATION BASIN CONSTRUCTION SHALL BE SUSPENDED DURING PERIODS OF RAINFALL OR SNOWMELT. CONSTRUCTION SHALL REMAIN SUSPENDED IF PONDED WATER IS PRESENT OR IF RESIDUAL SOIL MOISTURE CONTRIBUTES SIGNIFIGANTLY TO THE POTENTIAL FOR SOIL SMEARING, CLUMPING OR OTHER FORMS
- 3. AN ASSESSMENT OF THE ACTIVE EROSION IN THE DRAINAGE AREA TO THE INFILTRATION BASIN SHALL BE PERFORMED TO DETERMINE WHEN TO BRING THE INFILTRATION BASIN ON-LINE. THE BASIN SHALL BE BROUGHT ON-LINE WHEN THE AREA DRAINING TO THE BASIN HAS ACHIEVED 90% BUILD OUT OF ALL AREAS IN ANY OF THE FIRST 3 YEARS OR 75% BUILD OUT IN ANY SUBSEQUENT YEAR. BY 5 YEARS FROM THE START OF CONSTRUCTION IN THE DRAINAGE AREA, ALL INFILTRATION BASINS SHALL BE BROUGHT ON-LINE. BUILD OUT MEANS THAT THE AREA HAS BEEN FULLY DEVELOPED AND STABILIZED FROM EROSION. EROSION AND SEDIMENT CONTROL PRACTICES SHALL BE IMPLEMENTED FOR THE REMAINING 10-25% OF THE UNDEVELOPED AREAS WITH THE GOAL OF PREVENTING ANY SEDIMENT FROM REACHING THE INFILTRATION BASINS.
- 4. THE INFILTRATION AREAS SHALL BE FENCED OFF TO PREVENT HEAVY EQUIPMENT ACCESS DURING DEVELOPMENT.
- 5. IF THE ACTIVE INFILTRATION AREAS IS GRADED, THE EFFECTS OF COMPACTION SHALL BE MITIGATED USING THE FOLLOWING METHODS:
 - A. INCORPORATE SOIL ADDITIVES CONSISTING OF 2 INCHES OF COMPOST MIXED INTO 2 INCHES OF SAND.
 - B. THE SOIL MIX (V.C.3.b.1) SHALL BE INCORPORATED INTO THE EXISTING SOIL USING A CHISEL PLOW OR ROTARY DEVICE WITH THE CAPABILITY OF REACHING TO 12 INCHES BELOW THE EXISTING SURFACE.
 - C. THE COMPOST COMPONENT SHALL MEET THE WDNR SPECIFICATION \$100 COMPOST.
- 6. NATIVE VEGETATION SHALL BE ESTABLISHED IN CONFORMANCE WITH RECOMMENDATIONS FROM A QUALIFIED NATIVE NURSERY IN THE AREA. IF TREES ARE TO BE USED, SPECIES SHALL BE SELECTED THAT WILL NOT INTERFERE WITH THE FUNCTION OF THE BASIN, OR CAUSE MAINTENANCE PROBLEMS.
- 7. NATIVE (PRAIRIE) SEEDING SHALL BE COMPLETED IN THE FALL (AS DORMANT SEEDING PRIOR TO FIRST SNOW FALL) OR IN THE SPRING (BETWEEN MAY 1 AND JUNE 20), OR PLUGS SHALL BE USED.
- 8. TRACKED VEHICLES SHOULD BE USED DURING CONSTRUCTION TO LESSEN COMPACTION.
- 9. SNOW SHOULD NOT BE PLACED IN THE EFFECTIVE INFILTRATION AREA. IT MAY BE PLACED ON THE PRETREATMENT AREA OR AREAS DRAINING INTO THE PRETREATMENT AREA
- 10. SEE THE GRADING PLAN SHEETS FOR GRADING SURROUNDING THE BASINS.
- 11. IF STANDING WATER IS OBSERVED OVER 50% OF THE BASIN FLOOR 3 DAYS AFTER RAINFALL, THE BASIN IS CLOGGED AND MEASURES SHOULD BE TAKEN TO UNCLOG IT.
- 12. SEE THE DNR TECHNICAL STANDARD 1003 FOR MORE INFORMATION REGARDING OPERATION AND MAINTENANCE.




INFILTRATION BASIN DETAIL




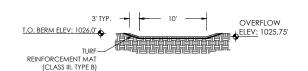

BROAD CRESTED OVERFLOW WIER

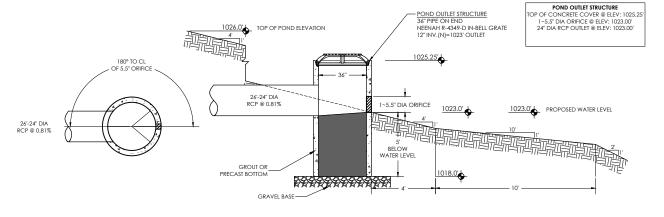

WET POND DETAIL

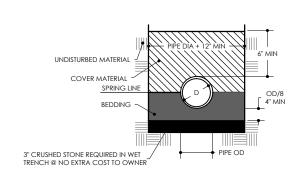

BEDDING AND COVER MATERIAL:

CLASS IA: CLEAN, ANGULAR CRUSHED STONE, CRUSHED ROCK, OR CRUSHED GRAVEL CONFORMING TO THE FOLLOWING GRADATION:

SIEVE SIZE	% PASSING BY WEIG
1"	100
3/4"	90-100
3/8"	20-55
NO. 4	0-10
NO. 8	0-5

CLASS IB: CLEAN, ANGULAR CRUSHED STONE, CRUSHED ROCK, OR CRUSHED GRAVEL CONFORMING TO THE FOLLOWING GRADATION:


SIEVE SIZE	% PASSING BY WEIGHT
1/2"	100
3/8"	85-100
NO. 4	10-30
NO. 200	0-5


CLASS II: CLEAN COARSE-GRAINED SOILS CLASSIFIED IN ASTM D2487 AS GW, GP,


CLASS III: COARSE-GRAINED SOILS WITH FINES CLASSIFIED IN ASTM D2487 AS GM. GC, SM, SC.

INSTALLATION: PLACE 4" OF BEDDING MATERIAL BENEATH PIPE. PLACE BEDDING MATERIAL AROUND THE PIPE TO THE SPRING LINE. WORK THE MATERIAL IN AND AROUND THE PIPE BY HAND TO PROVIDE UNIFORM SUPPORT. PLACE COVER MATERIAL CAREFULLY TO A LEVEL 6" ABOVE THE PIPE.

RIGID PIPE BEDDING (RCP)

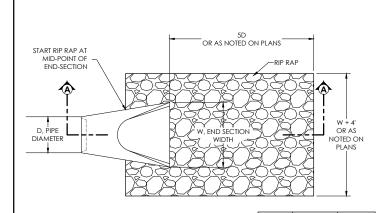

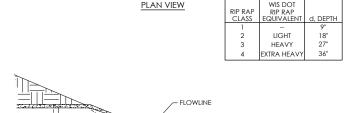

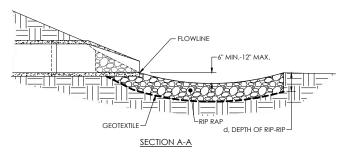

AS NOTED

REVIEWED BY ISSUE DATE APRIL 23. 2019 GEC FILE NO. 2-1118-526 SHEET NO.

RIP RAP AT PIPE DISCHARGE

RCP PIPE

General Engineering Company

SEWER CONSTRUCTION DETAILS
RACE DAY EVENTS
SUPREME STRUCTURES


STORM

CITY OF FITCHBURG DANE COUNTY, WI


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PRELIMINARY NOT FOR CONSTRUCTION



2'x3' CURB INLET

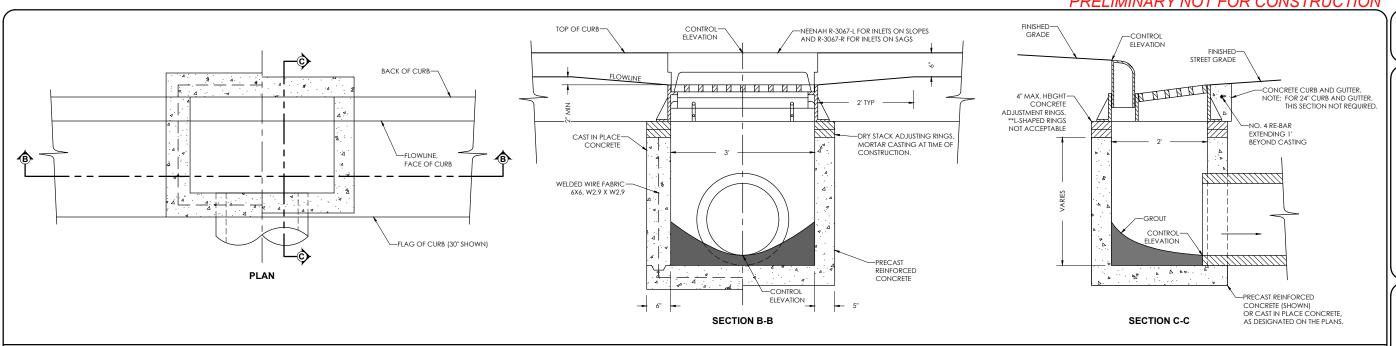

MANHOLE / INLET NOTES:

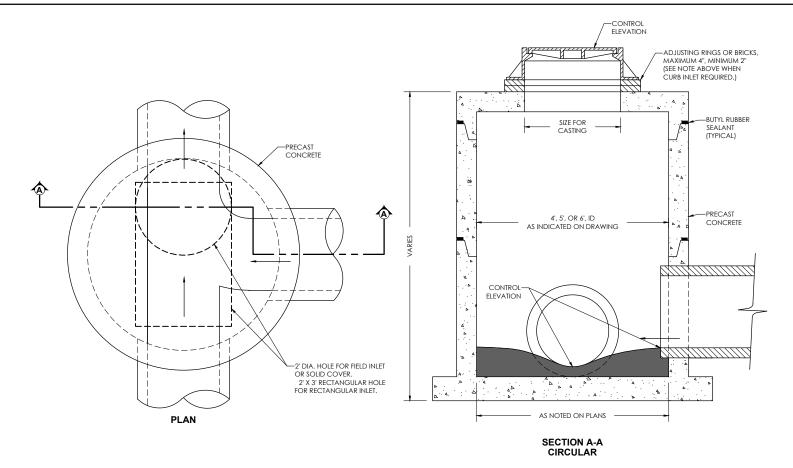- CURB INLET: NEENAH R-3067-L FOR INLETS ON SLOPES, NEENAH R-3067-R FOR INLETS ON SAGS AND NEENAH R-3290-A FOR INLETS IN DRIVEWAY.
- 2. FIELD INLET: NEENAH R-2501, TYPE C LID, OR EQUAL.
- 3. SOLID COVER: NEENAH R-1556 WITH TYPE B NON-ROCKING LID.
- 4. BEEHIVE INLET: NEENAH R-2560-E5 OR EQUAL.
- 5. WHEN MH CASTING IS USED, AN ECCENTRIC CONE TOP SHALL BE USED IF MH HAS ENOUGH DEPTH.

6. PROVIDE MANHOLE STEPS, 16" O.C. FOR STRUCTURES WHEN DEPTH IS OVER 4'. MANHOLE STEPS SHALL CONFORM TO THE SPECIFICATIONS.


STORM SEWER MANHOLE / INLET



General Engineering Company

STORM SEWER MANHOLE & INLETS
RACE DAY EVENTS
SUPREME STRUCTURES


CITY OF FITCHBURG DANE COUNTY, WI

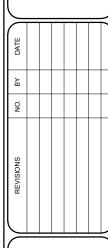



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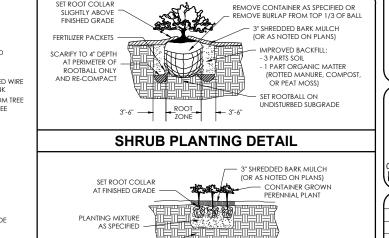
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EVERGREEN TREE PLANTING DETAIL



GROUNDCOVER/PERENNIAL PLANTING DETAIL

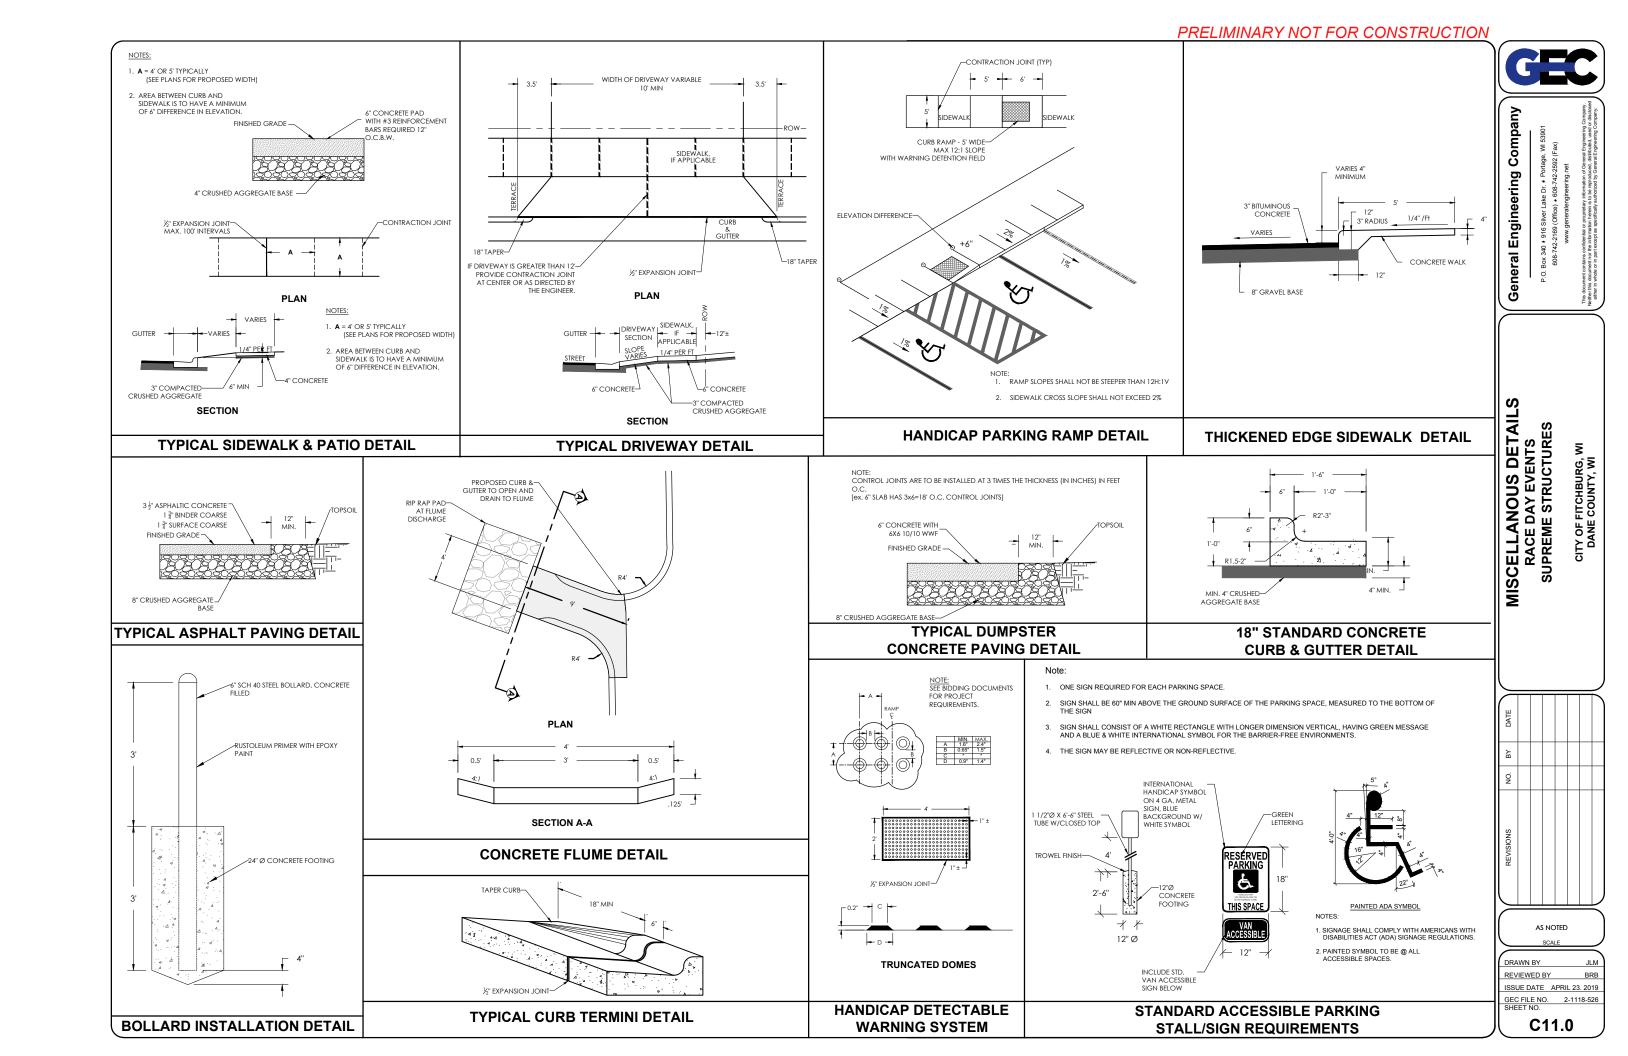DRAWN BY REVIEWED BY ISSUE DATE APRIL 23. 2019

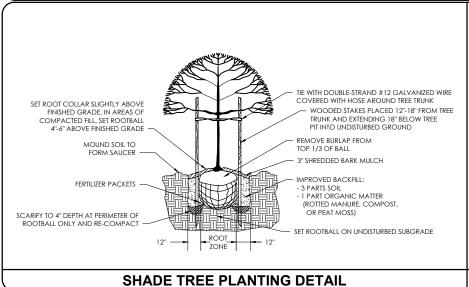Company

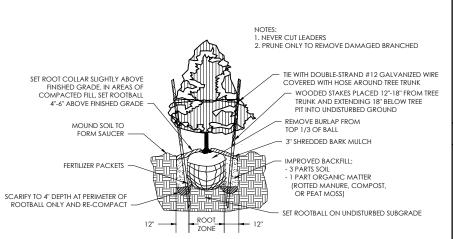
Engineering

General


LANDSCAPE PLAN & DETAIL RACE DAY EVENTS SUPREME STRUCTURES CITY OF FITCHBURG DANE COUNTY, WI

GEC FILE NO. 2-1118-526 SHEET NO.

C12.0

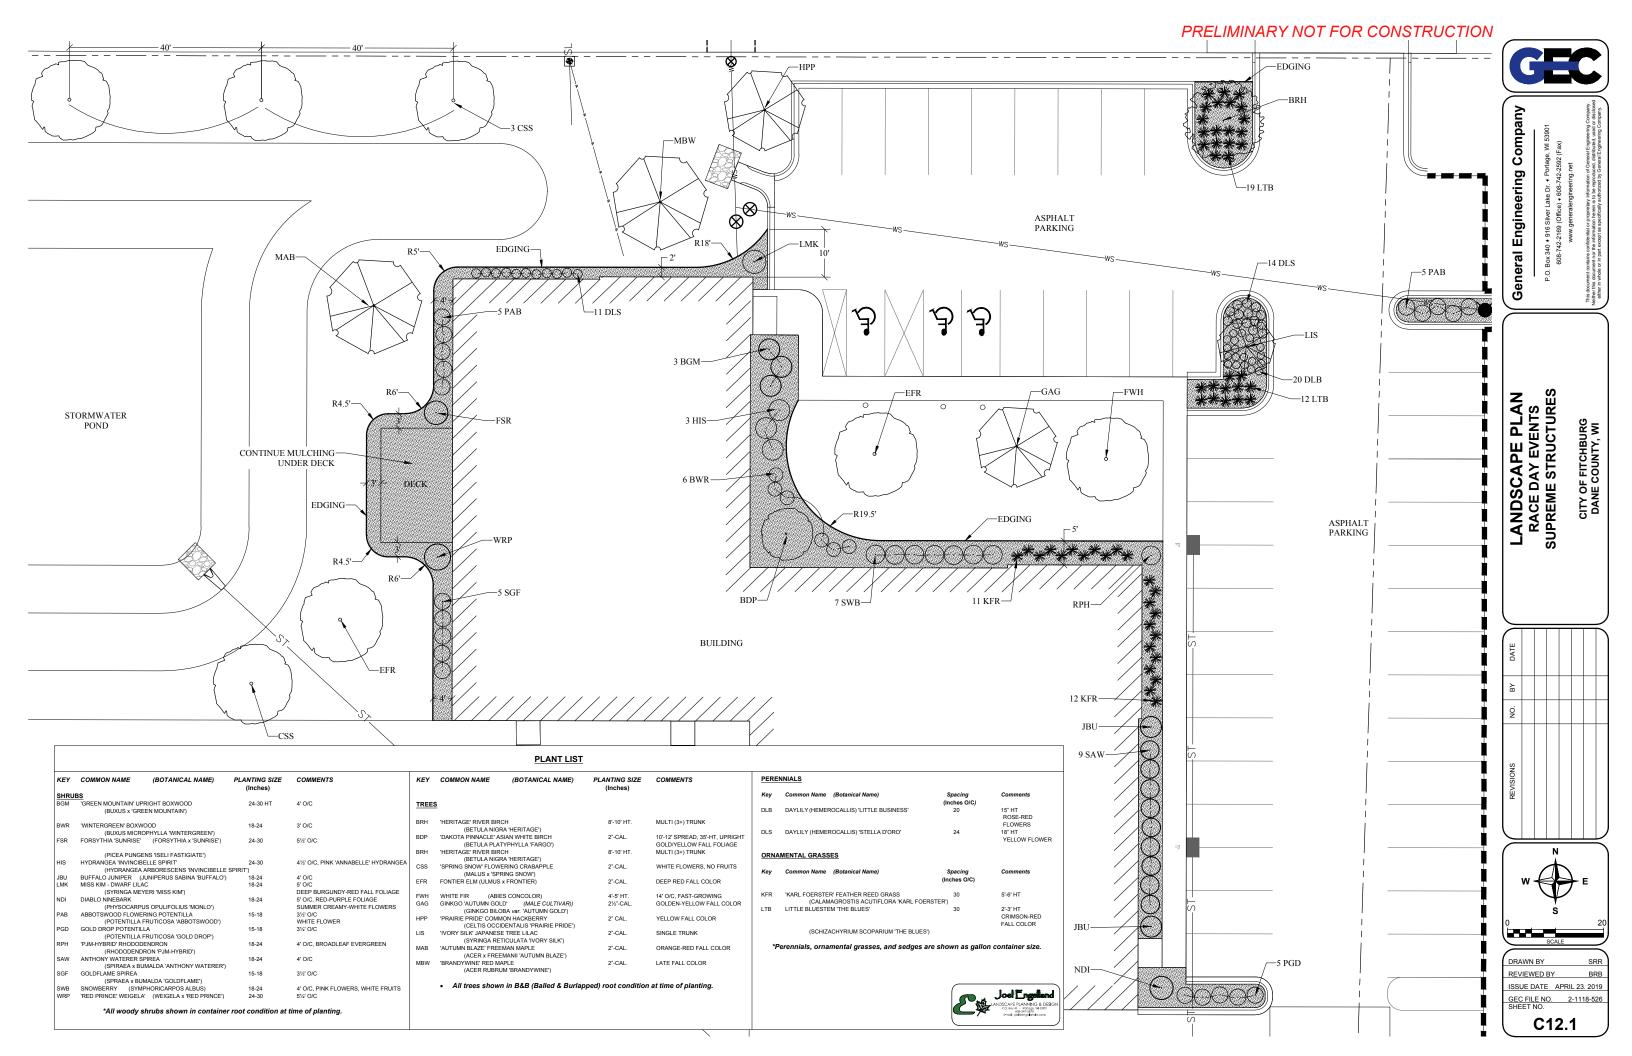

SUBZERO PARKWAY

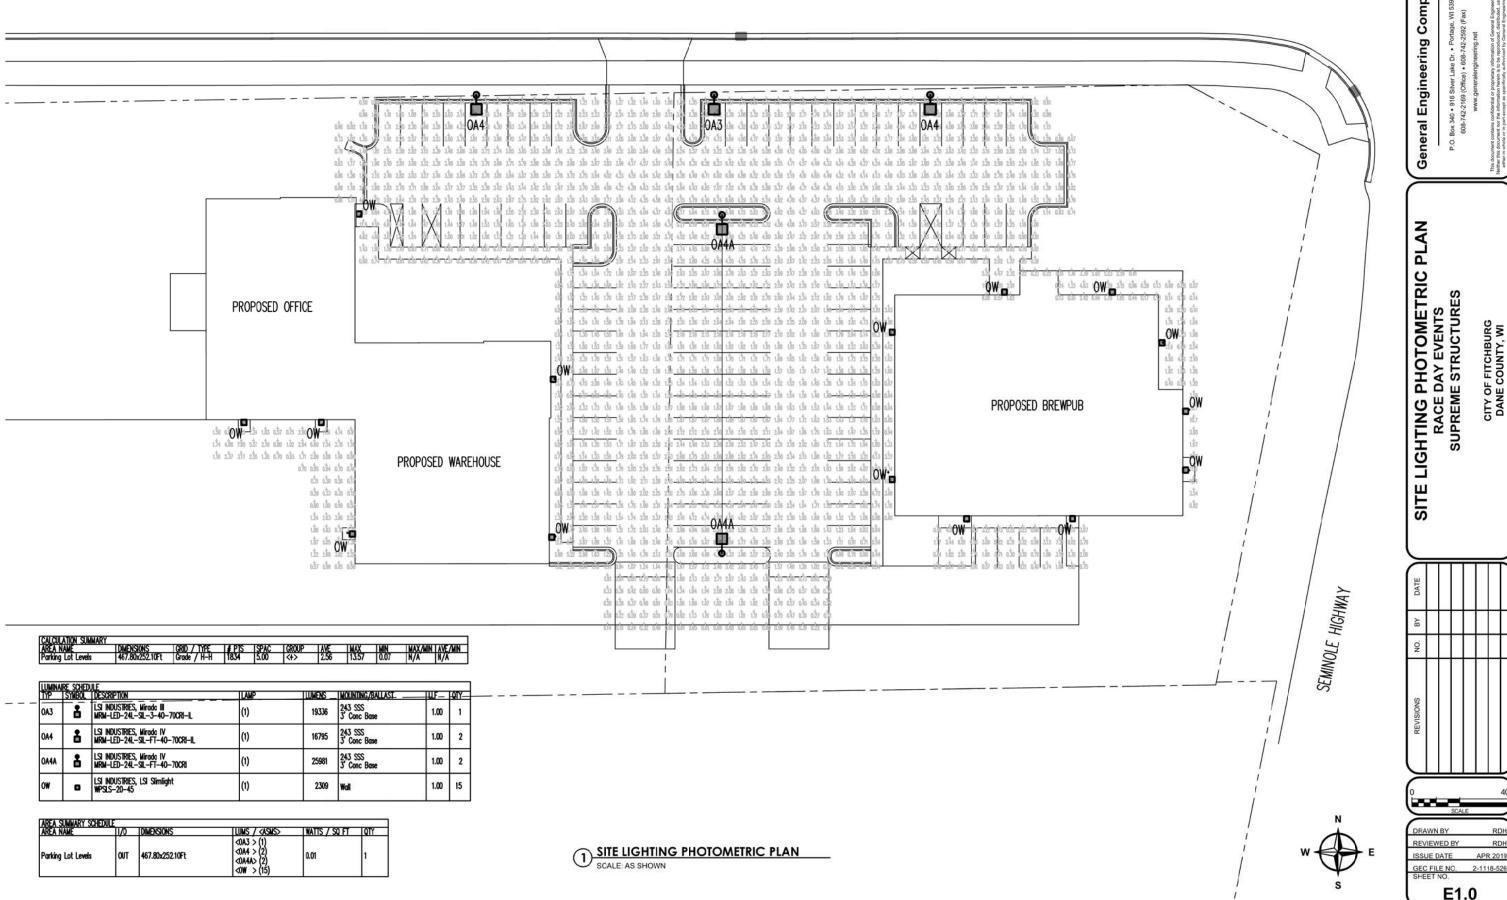



HEBERT DESIGN 5129 Flambeau Rd. (608) 289-6229 Madison, WI 53705

THESE DRAWINGS ARE FOR BIDDING AND CONSTRUCTION PURPOSES ONLY. THE GENERAL CONTRACTOR IS RESPONSIBLE FOR THE WORK PERFORMED AND THE ACCURACY AND PERFORMANCE THEREIN

BUILDING INFORMATION:
Race Day Events Offices and Storage Facility

PROPOSED:

- Fully sprinklered.

ANSI A117.1

- Use of Type IIB construction

REQUIRED CODE COMPLIANCE:

BUILDING CODE INFORMATION

SMOKE ALARM SYSTEM:

NUMBER OF EXITS PER FLOOR:

OCCUPANT LOADS AND EGRESS

CODE PLAN LEGEND

B (BUSINESS) OCCUPANCY

S-1 (STORAGE) OCCUPANCY

SPRINKLER SYSTEM:

Corner of Seminole Hwy and Sub-Zero Pkwy, Fitchburg, Wisconsin

State of Wisconsin's Commercial Building Code: SPS 361-365 - 2015 International Building Code

State of Wisconsin's Fire Prevention Chapter SPS 314

- 2015 NFPA 101: Life Safety Code

Mixed, non-separated storage (warehouse) and business (offices) space. Use classified as S-1/B

- Non-combustible construction with unprotected elements.

3 (IBC TABLE 504.4) 75' (IBC TABLE 504.3)

BUILDING CODE NOTES:

1. "ALLOWED/REQUIRED" FIGURES DETERMINED USING S-1/B OCCUPANCY WITH A TYPE IIB CONSTRUCTION, FULLY SPRINKLERED - REQUIREMENTS OF S-1 OCCUPANCY MET

OCCUPANCY AREA OCC. LOAD REQ. EGRESS WIDTH PROVIDED 7,358 SF /500 GROSS = 15 x 0.2" = 3"

OCCUPANCY AREA OCC. LOAD REQ. EGRESS WIDTH PROVIDED

TOTALS DETERMINED PER 2015 IBC CHAPTER 10
 GROSS FLOOR AREAS USED ARE INDICATED BY COLORED AREAS ON CODE PLANS

2,248 SF /100 GROSS = 25 x 0.2" = 5"

5,551 SF /100 GROSS = 56 x 0.2" = 11.2" 66" TOTAL

52,500 SF/FLR (506.2) 1ST: 13,162 SF

2ND: 2,446 SF TOTAL: 15,608 SF

PER IBC CH. 9

PER IBC CH. 9

2 (MIN. PER SPACE)

EGRESS PATH

ERO AND SEMINOLE RACE

FITCHBURG,

10	ARCHITECTURAL REVIEW	4.23.19
1	PERMIT SET	4.19.19
lo.	Description	Date
	Document Release	

Drn:J Donahue


Sheet Name **CODE PLANS** AND CODE **INFORMATION**

Scale: 1/8" = 1'-0"

Sheet Number


FIRST FLOOR CODE PLAN

SCALE: 1/8" = 1'-0"

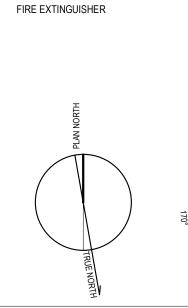

ACCESSIBLE SINK IN COUNTERTOP


SCALE: 3/4" = 1'-0"

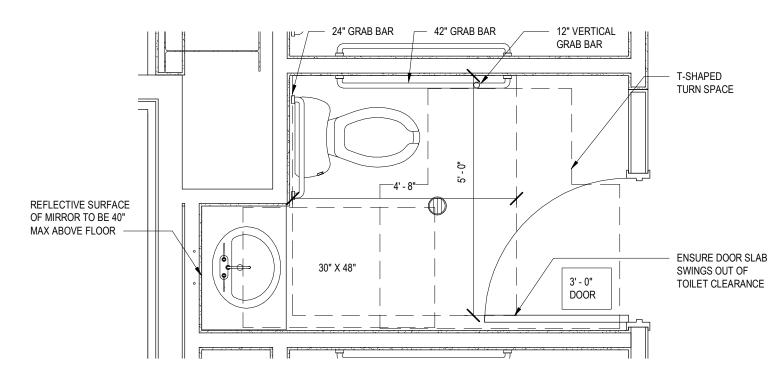

NOTES:

1. RESTROOMS TO BE ACCESSIBLE PER ANSI A 117.1 CLEARANCE MEASUREMENTS ARE MEASURED FROM FINISHES

TYPICAL SINGLE USER TOILET ROOM

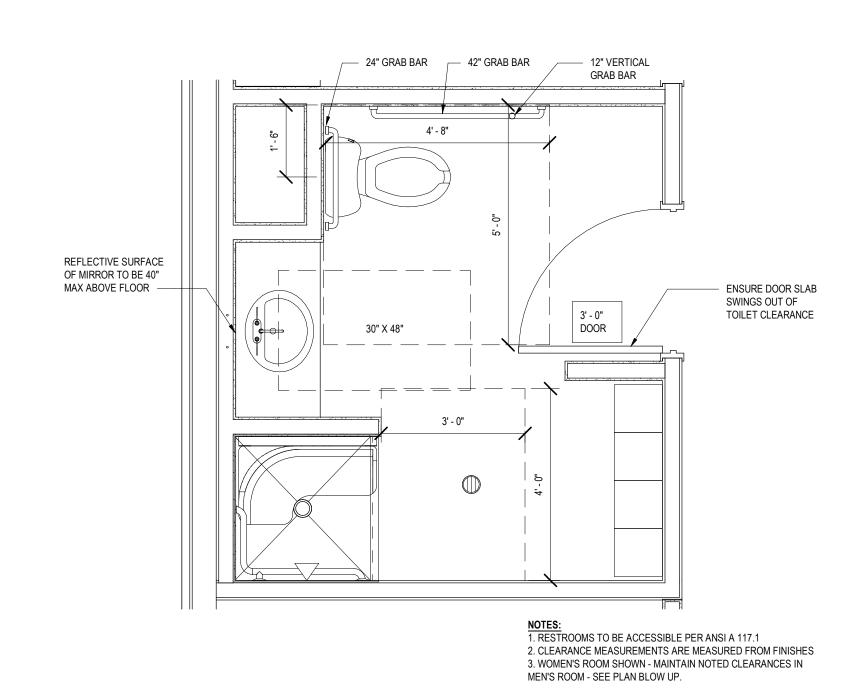

FIXTURE COUNTS

B (2ND FLR)

WATER CLOSETS - ENTIRE BUILDING					
OCCUPANCY	OCC. LOAD	REQ. WATER CLOSET	PROVIDED		
S-1	15	- 50/25 = 2 WATER CLOSETS REQ +			
B (1ST FLR)	56	- 46/50 = 1 WATER CLOSETS REQ			
B (2ND FLR)	25	40/30 - I WATER CLOSE IS REQ			
TOTAL	96	3 WATER CLOSETS REQ	4 WATER CLOSETS		
LAVATORIES - ENT	RE BUILDING				
OCCUPANCY	OCC. LOAD	REQ. LAVATORIES	PROVIDED		
S-1	15	- 80/40 = 2 LAVATORIES REQ +			
B (1ST FLR)	56	- 16/80 = 1 LAVATORY REQ			
		10/00 - ILAVATORT REQ			

3 LAVATORIES REQ 4 LAVATORIES FIXTURE COUNT NOTES:

1. "REQUIRED" FIXTURE COUNTS DETERMINED USING S-1/B OCCUPANCY - REQUIREMENTS OF B OCCUPANCY MET 2. DRINKING WATER AVAILABLE AT KITCHENETTE - FOR AHJ APPROVAL

TYPICAL TOILET/SHOWER ROOM

SCALE: 1/2" = 1'-0"

HEBERT DESIGN 5129 Flambeau Rd.

(608) 289-6229 Madison, WI 53705

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AND PERFORMANCE THEREIN

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AND FITCHBURG, ACE OF


10	ARCHITECTURAL REVIEW	4.23.19
1	PERMIT SET	4.19.19
No.	Description	Date
Document Release		

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CODE PLANS AND CODE **INFORMATION**

Scale: As indicated

Sheet Number **A002**

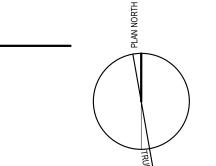

SECOND FLOOR CODE PLAN SCALE: 1/8" = 1'-0"

33" CLEAR OPENING, TRAVEL DISTANCE: 140' - 0"

OCCUPANT LOADS AND EGRESS

1. TOTALS DETERMINED PER 2015 IBC CHAPTER 10

B (BUSINESS) OCCUPANCY

S-1 (STORAGE) OCCUPANCY

OFFICE

C-SUITE

OCCUPANCY AREA OCC. LOAD REQ. EGRESS WIDTH PROVIDED 7,358 SF /500 GROSS = 15 x 0.2" = 3"

5,551 SF /100 GROSS = 56 x 0.2" = 11.2"

OCCUPANCY AREA OCC. LOAD REQ. EGRESS WIDTH PROVIDED

2. GROSS FLOOR AREAS USED ARE INDICATED BY COLORED AREAS ON CODE PLANS

2,248 SF /100 GROSS = 25 x 0.2" = 5"

66" TOTAL

EGRESS PATH

FIRE EXTINGUISHER

OFFICE

C-SUITE

C-SUITE

OPEN WORK SPACE

FIRST FLOOR

SECOND FLOOR

CODE PLAN LEGEND

TRAVEL DISTANCE AT

STAIRS MEASURED BY

ANGLE OF DESCENT

33" CLEAR OPENING,

TRAVEL DISTANCE:

OFFICE

OFFICE

MEASURED TO FRONT ENTRANCE ON FIRST FLOOR

TRAVEL DISTANCE AT STAIRS MEASURED BY

ANGLE OF DESCENT


STAIR

104' - 9"

OFFICE

C-SUITE

MEASURED TO BACK EXIT ON FIRST FLOOR

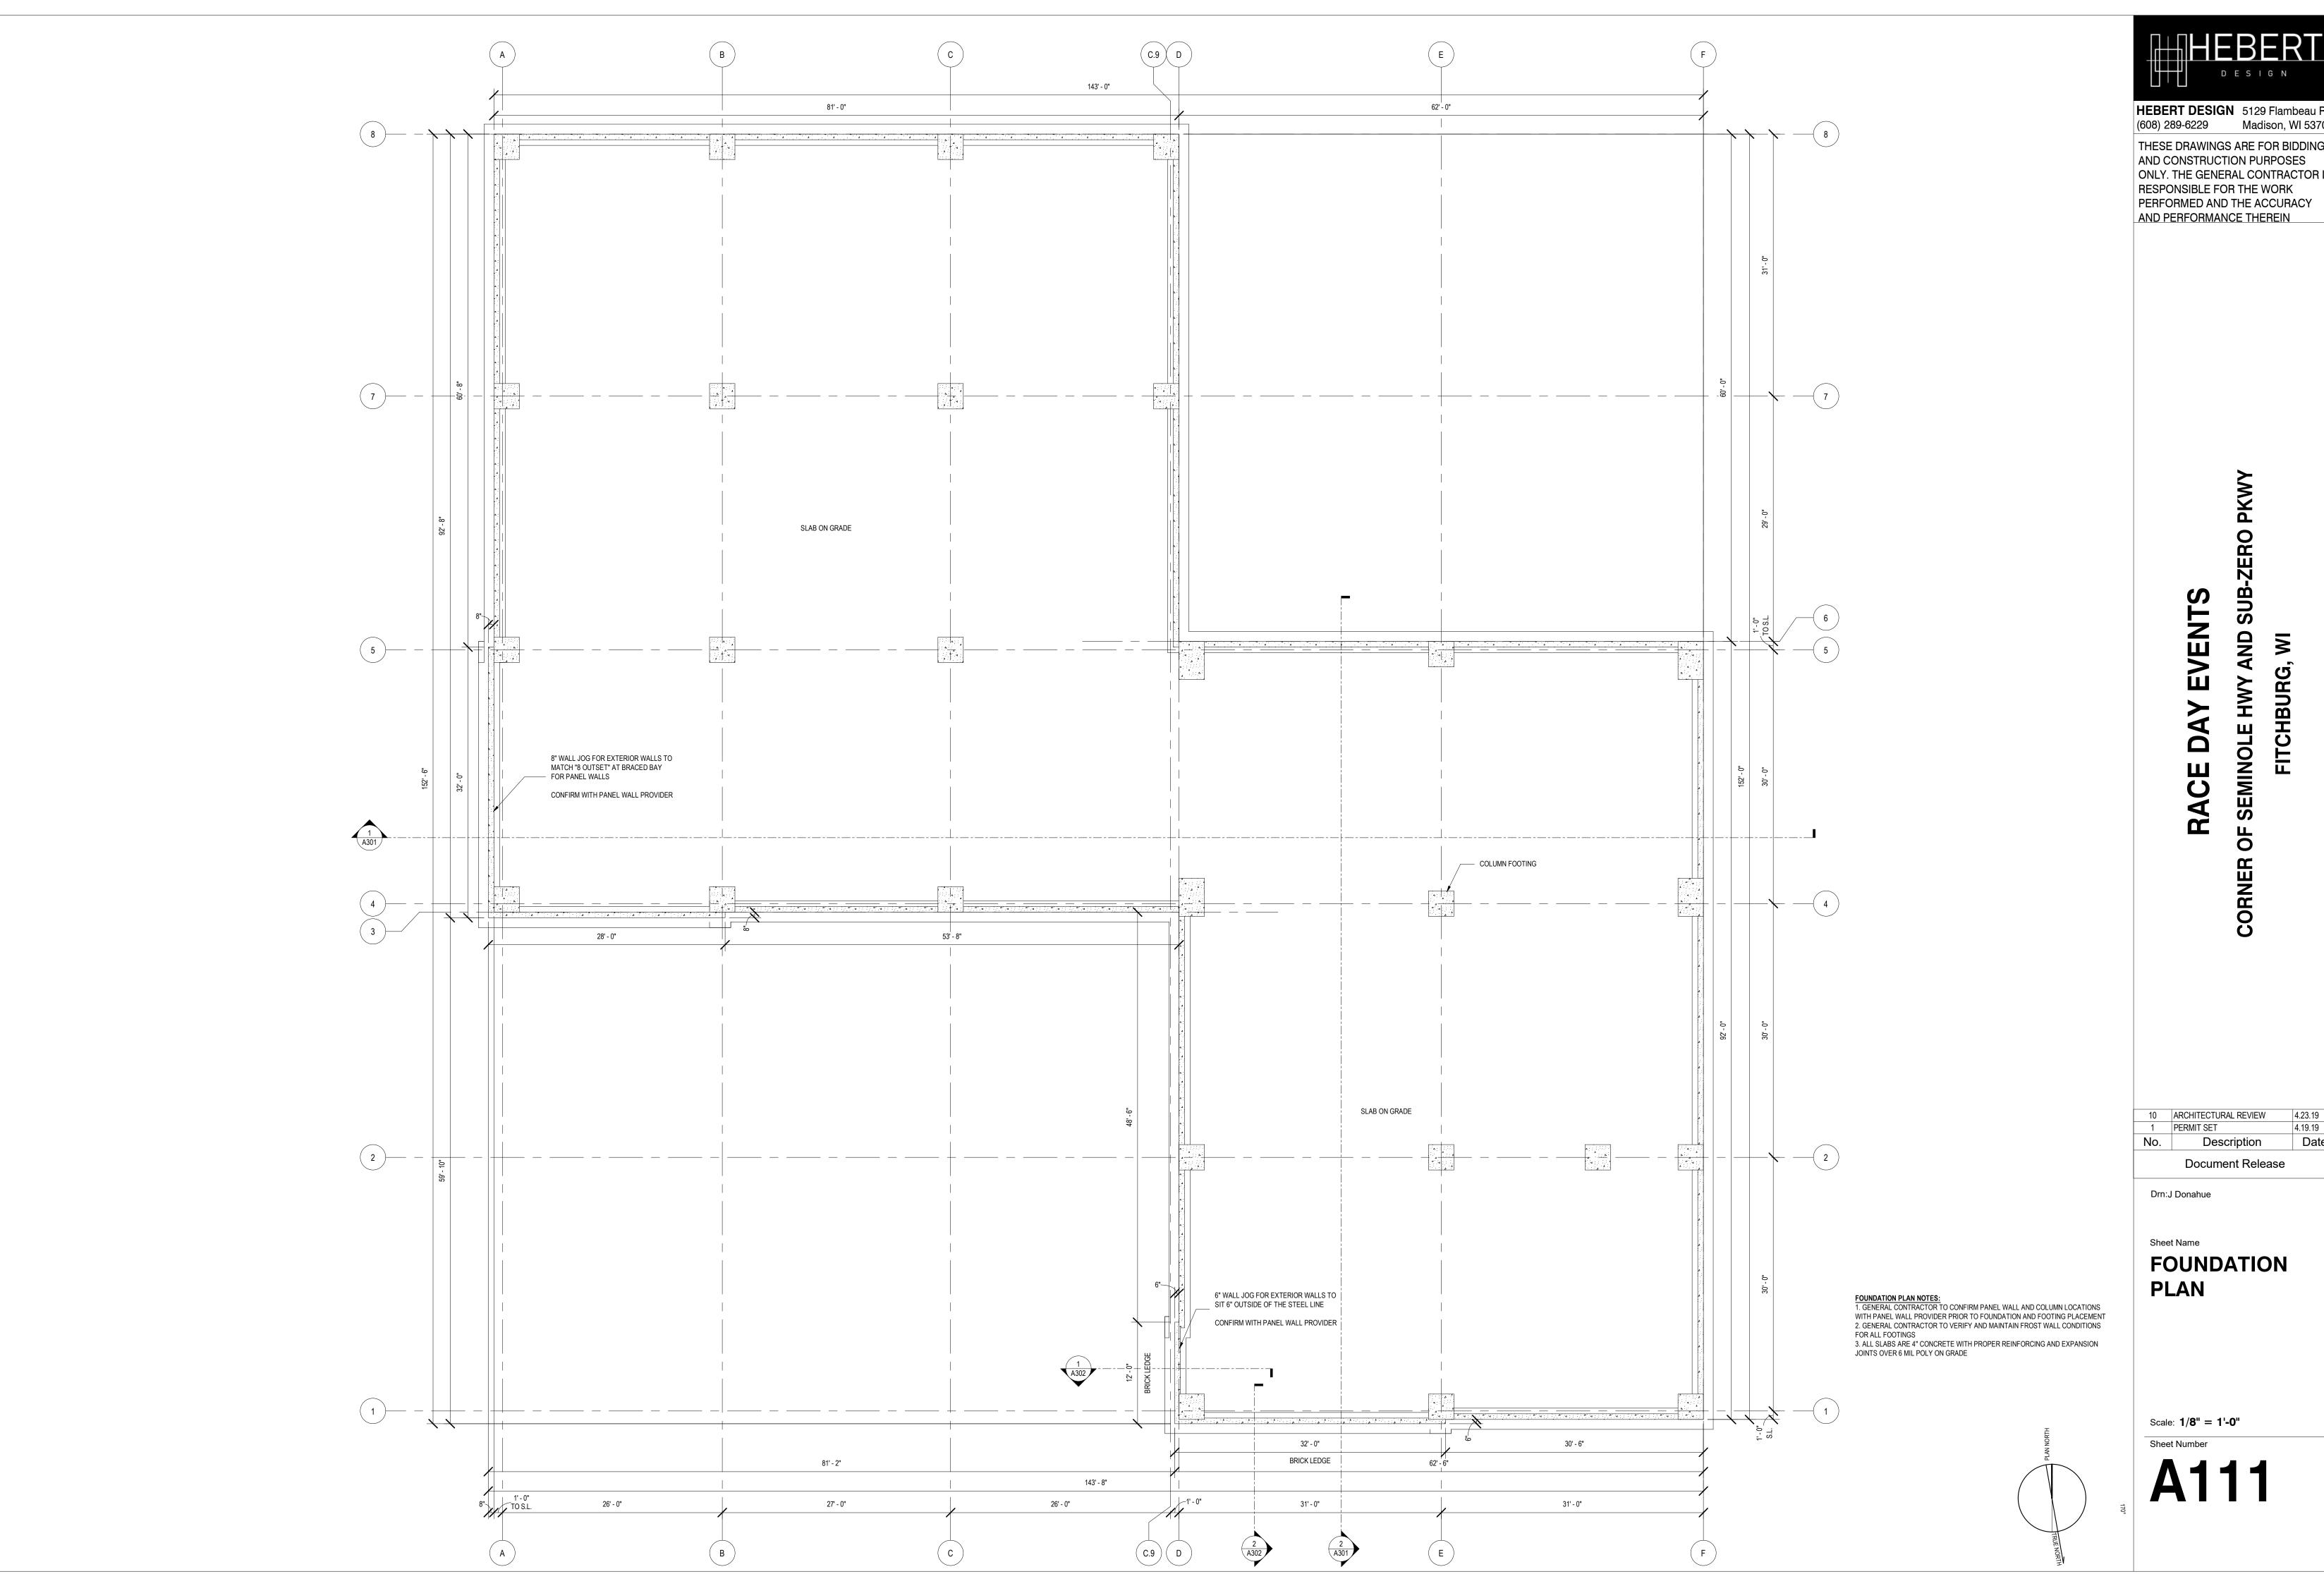



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FITCHBURG,

DAY

RACE

Description Document Release


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Sheet Name

FOUNDATION PLAN

Scale: 1/8" = 1'-0"

Sheet Number



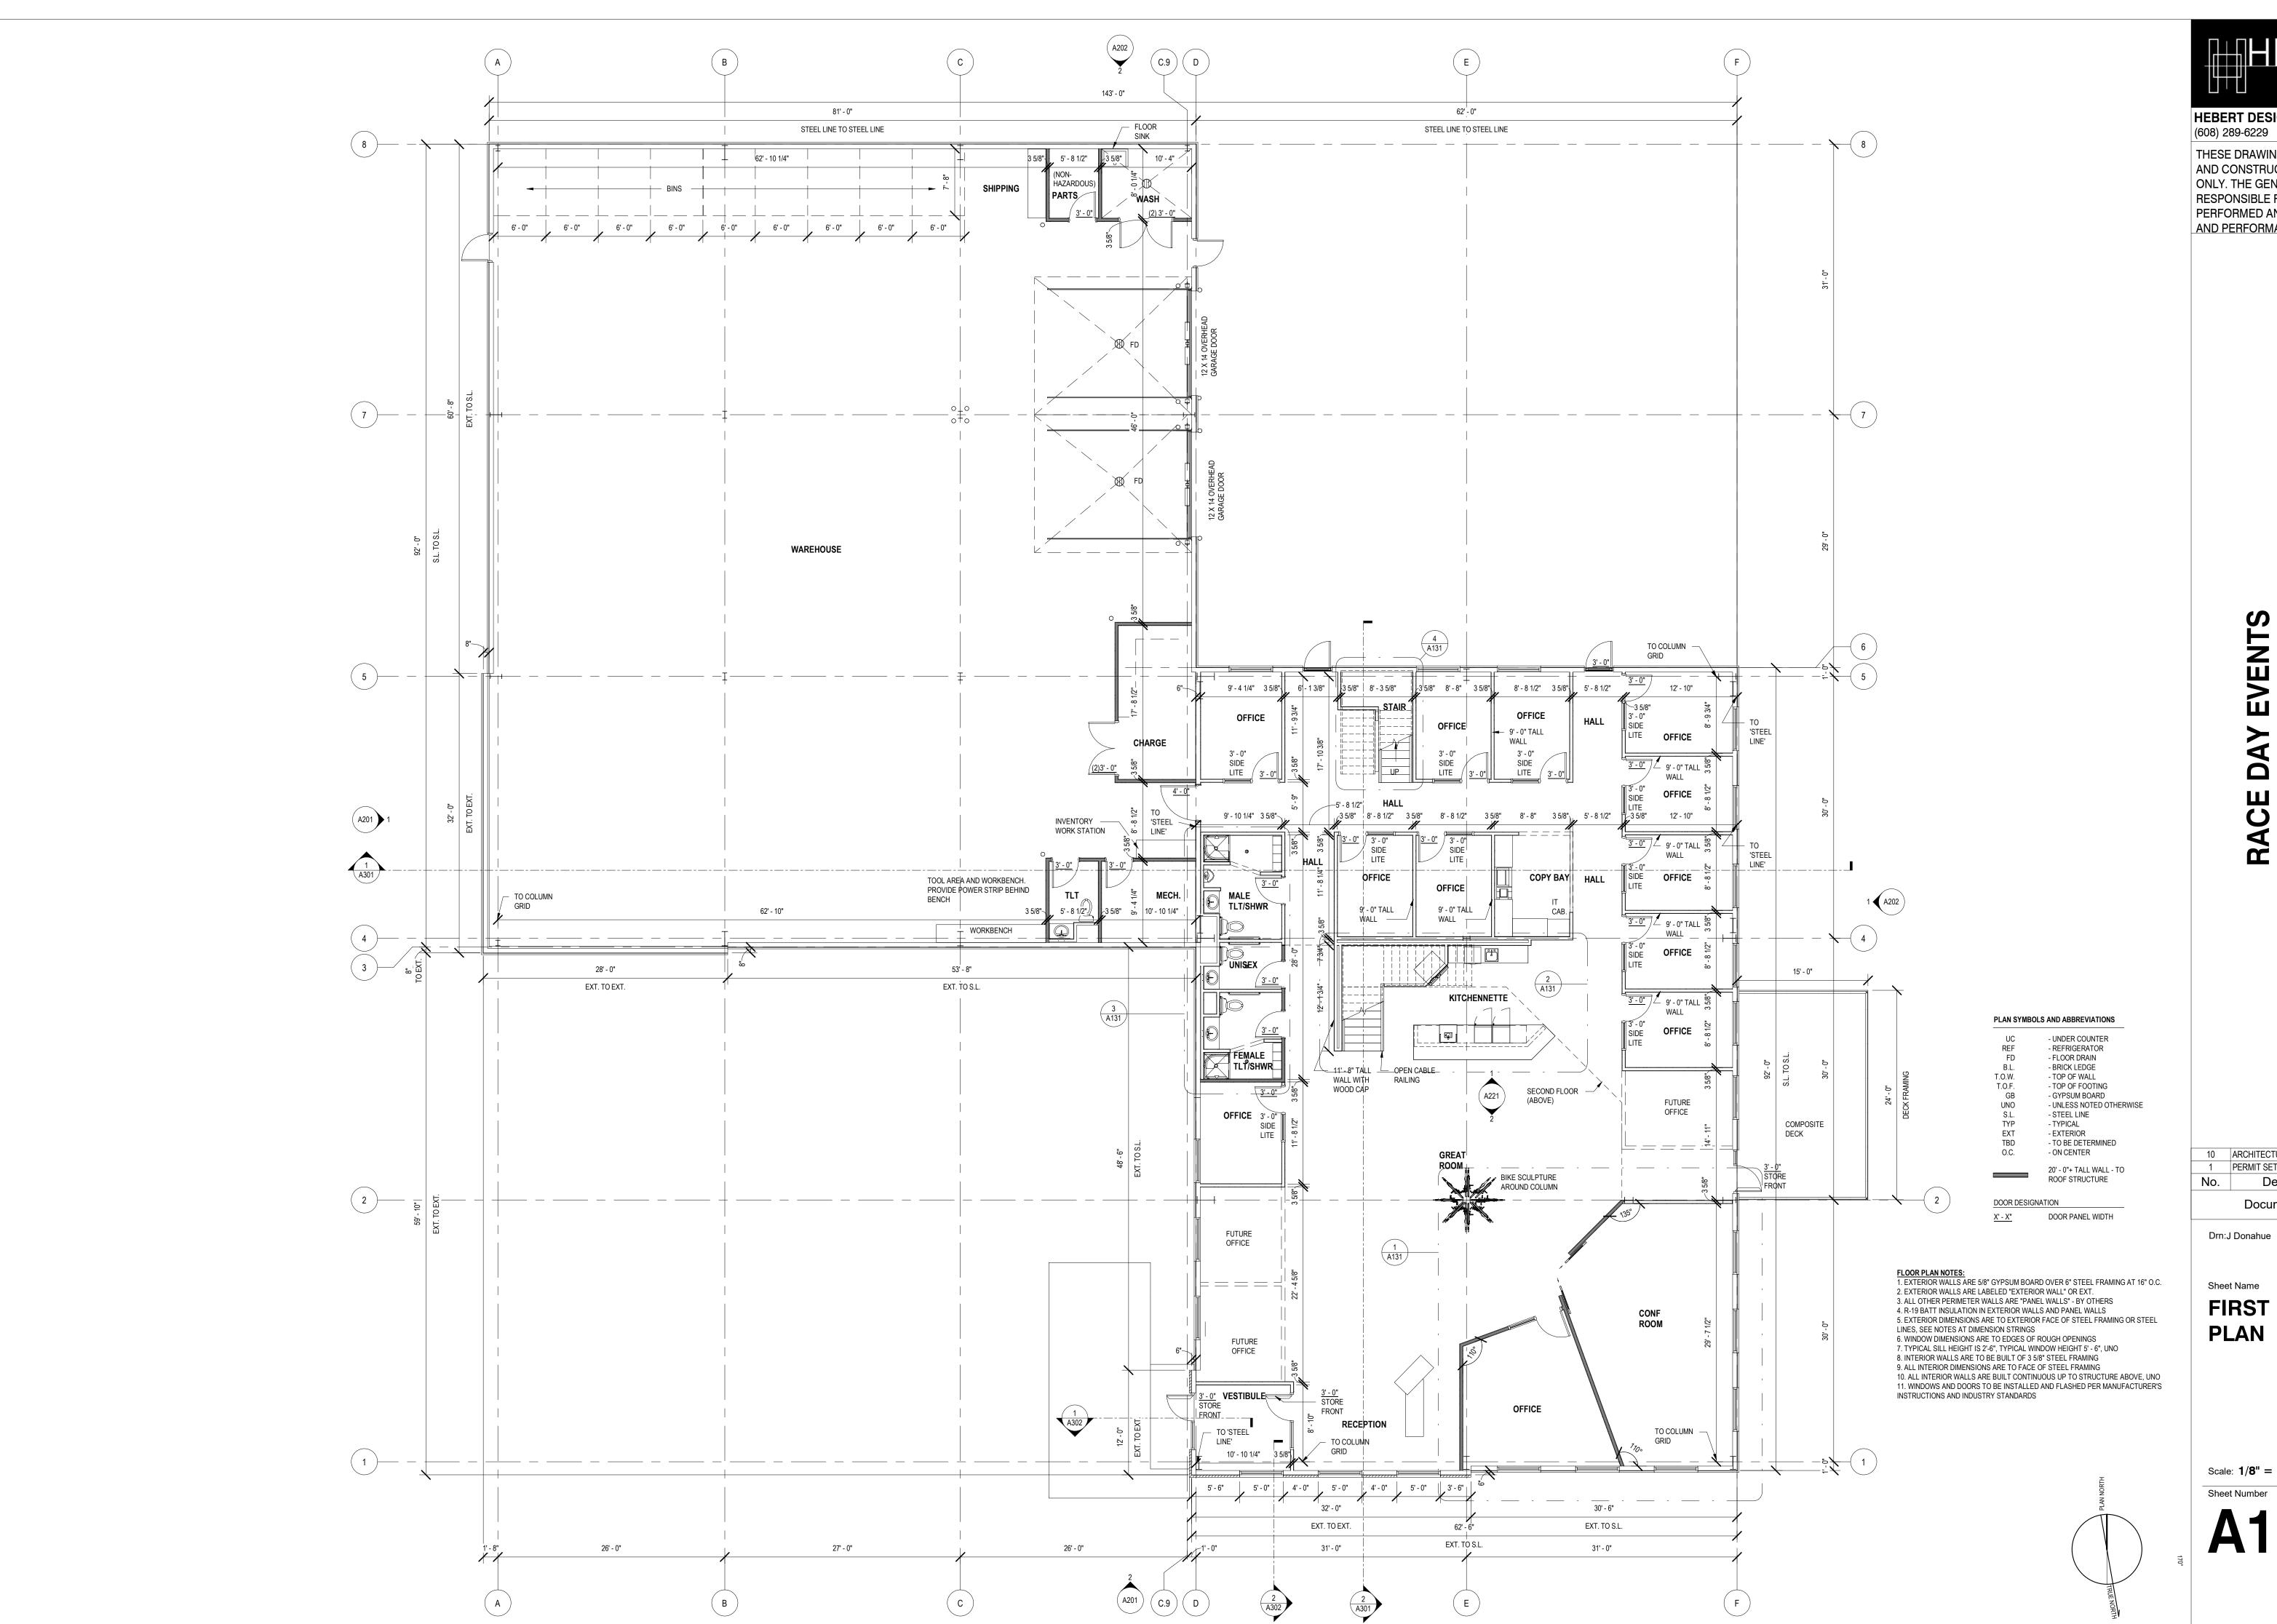

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10 ARCHITECTURAL REVIEW 4.23.19 PERMIT SET 4.19.19 Description Date

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Sheet Name FIRST FLOOR **PLAN**

Scale: 1/8" = 1'-0"

Sheet Number

SUB-ZERO

AND

SEMINOLE HWY


OF

FITCHBURG,

EVENTS

DAY

RACE

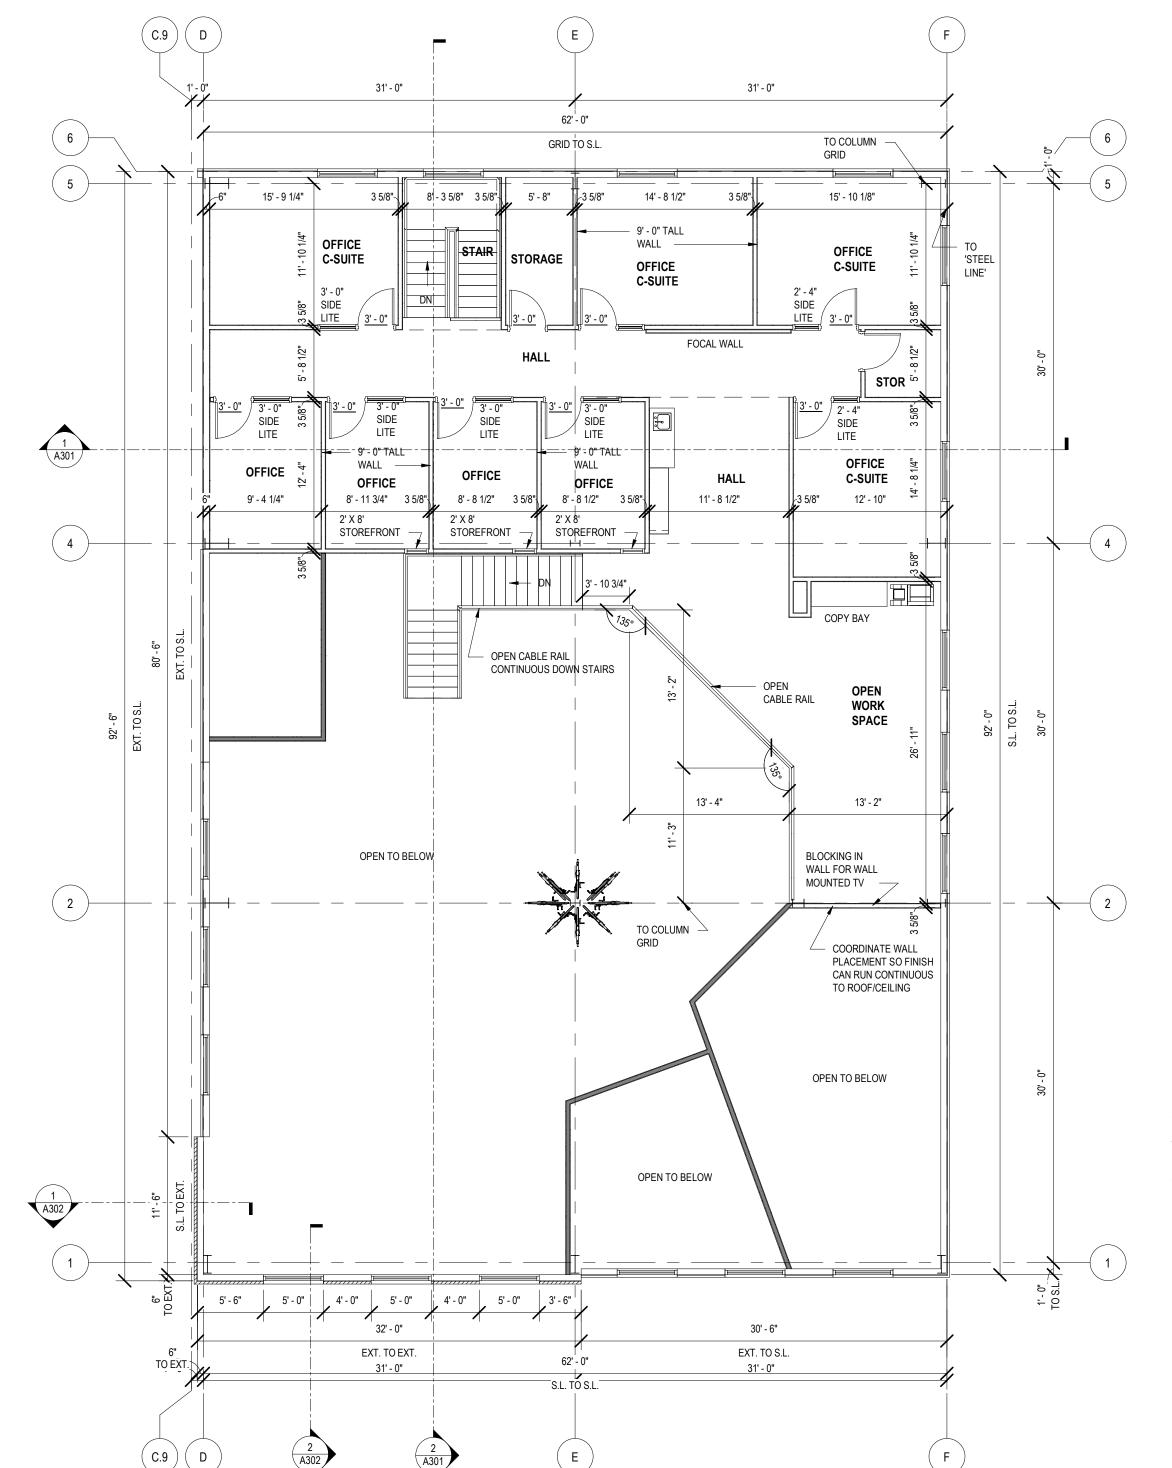

PLAN SYMBOLS AND ABBREVIATIONS

- REFRIGERATOR - FLOOR DRAIN - BRICK LEDGE - TOP OF WALL - TOP OF FOOTING - GYPSUM BOARD UNO S.L. TYP EXT - UNLESS NOTED OTHERWISE


- STEEL LINE - TYPICAL - EXTERIOR - TO BE DETERMINED - ON CENTER


20' - 0"+ TALL WALL - TO ROOF STRUCTURE

DOOR DESIGNATION X' - X" DOOR PANEL WIDTH

FLOOR PLAN NOTES: 1. EXTERIOR WALLS ARE 5/8" GYPSUM BOARD OVER 6" STEEL FRAMING AT 16" O.C. 2. EXTERIOR WALLS ARE LABELED "EXTERIOR WALL" OR EXT. 3. ALL OTHER PERIMETER WALLS ARE "PANEL WALLS" - BY OTHERS

- 4. R-19 BATT INSULATION IN EXTERIOR WALLS AND PANEL WALLS 5. EXTERIOR DIMENSIONS ARE TO EXTERIOR FACE OF STEEL FRAMING OR STEEL
- LINES, SEE NOTES AT DIMENSION STRINGS 6. WINDOW DIMENSIONS ARE TO EDGES OF ROUGH OPENINGS 7. TYPICAL SILL HEIGHT IS 2'-6", UNO
- 8. INTERIOR WALLS ARE TO BE BUILT OF 3 5/8" STEEL FRAMING 9. ALL INTERIOR DIMENSIONS ARE TO FACE OF STEEL FRAMING 10. ALL INTERIOR WALLS ARE BUILT CONTINUOUS UP TO STRUCTURE ABOVE, UNO 11. WINDOWS AND DOORS TO BE INSTALLED AND FLASHED PER MANUFACTURER'S INSTRUCTIONS AND INDUSTRY STANDARDS

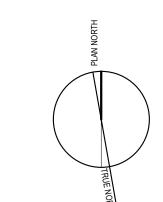

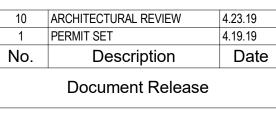

Drn:J Donahue

Sheet Name **SECOND FLOOR PLAN**

Scale: 1/8" = 1'-0"

Sheet Number

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FITCHBURG, \

OF

CORNER

SIGNAGE

- METAL PANEL SIDING - ROYAL BLUE

SECOND FLOOR 112' - 0"


- BRICK FACED - WHITE TUMBLED BRICK

- STOREFRONT DOOR -

FIRST FLOOR 100' - 0"

Scale: 1/8" = 1'-0"

Sheet Number

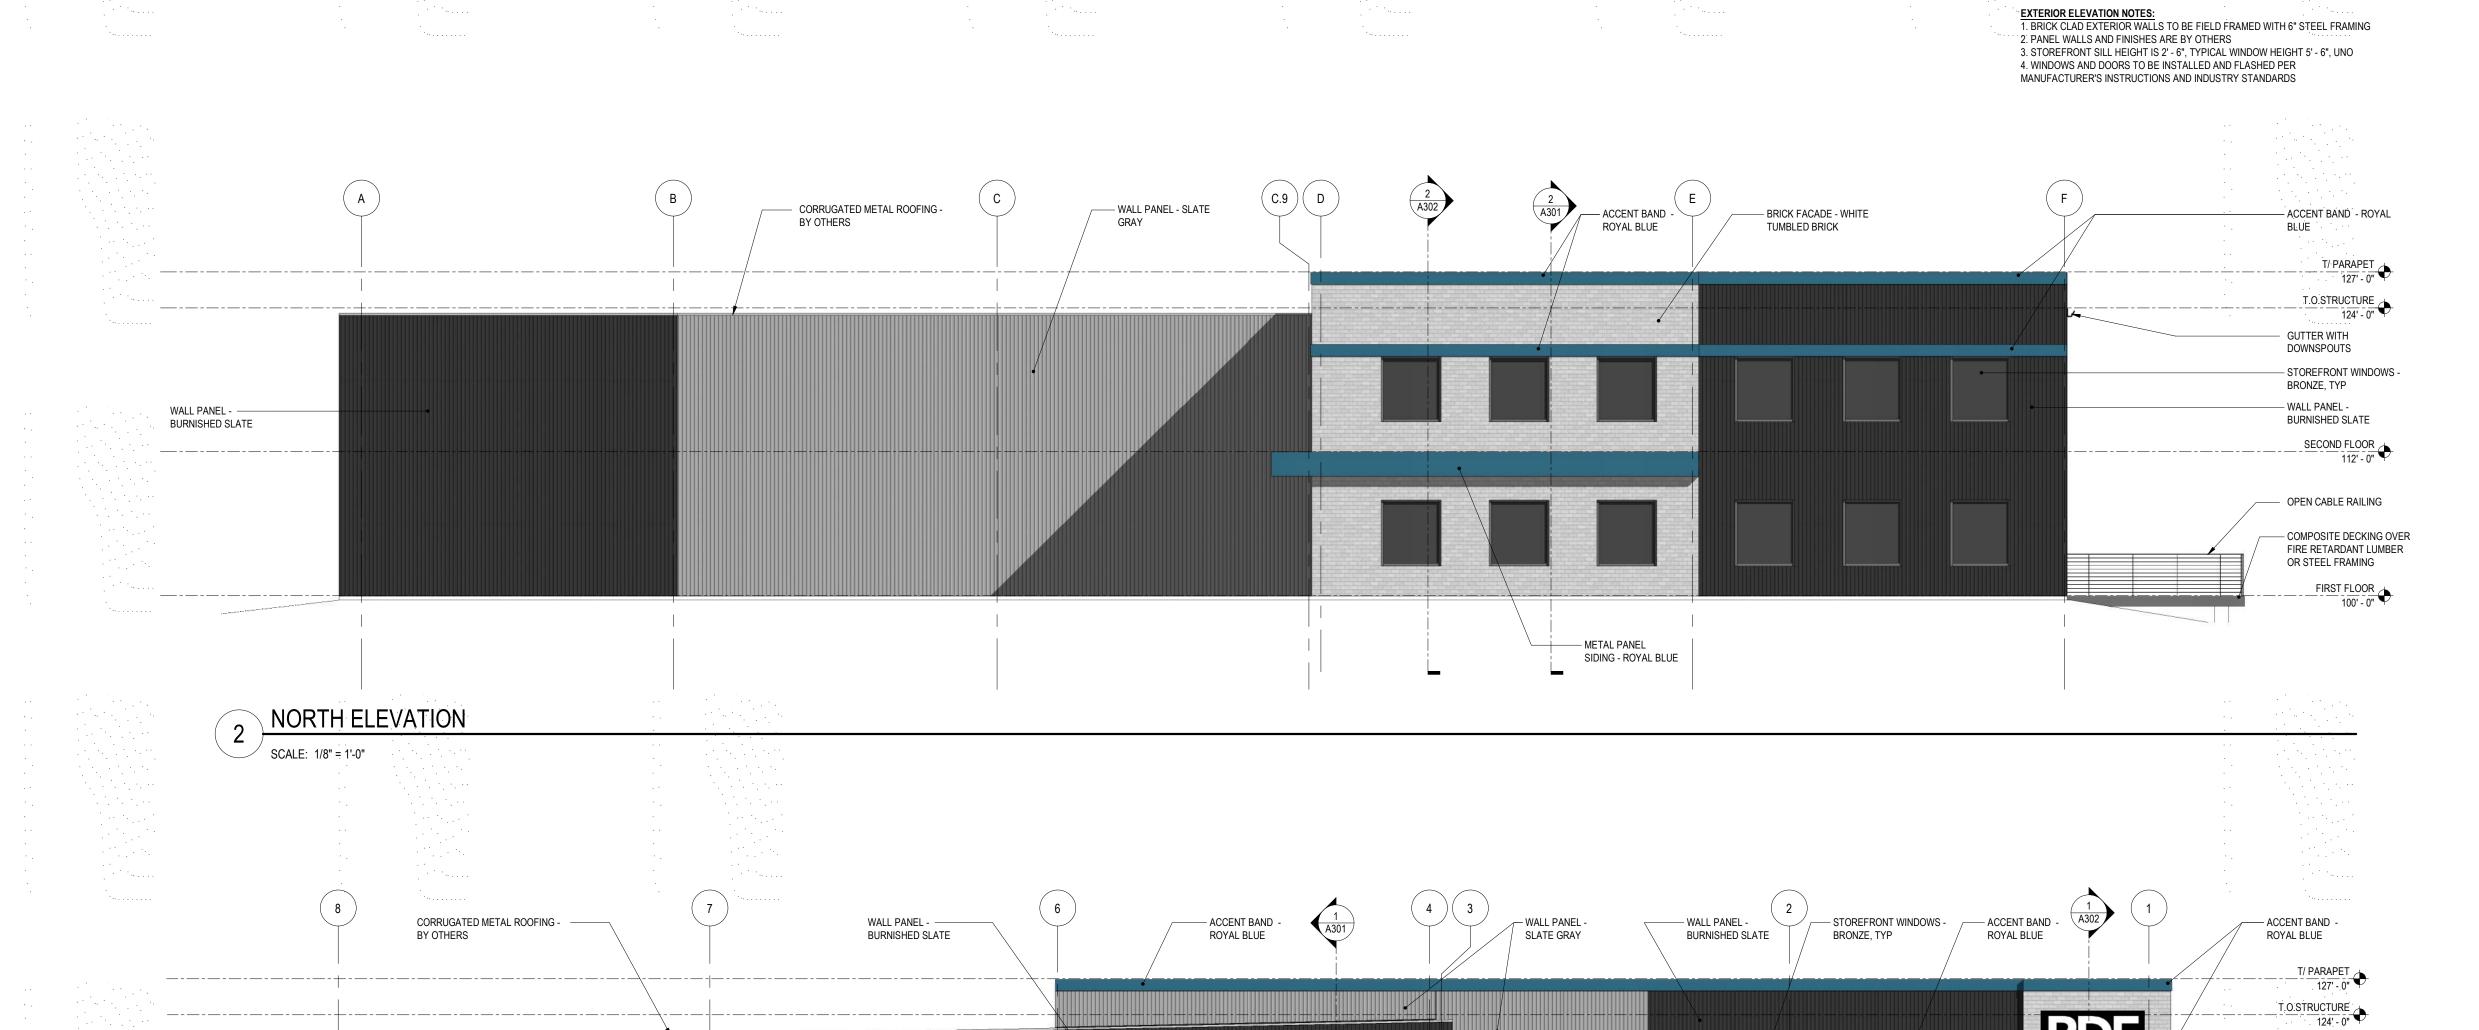

GUTTER WITH

DOWNSPOUTS

WALL PANEL - SLATE ----

EAST ELEVATION

SCALE: 1/8" = 1'-0"

- STEEL DOOR - PAINT TO MATCH PANEL WALL

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FITCHBURG, 1


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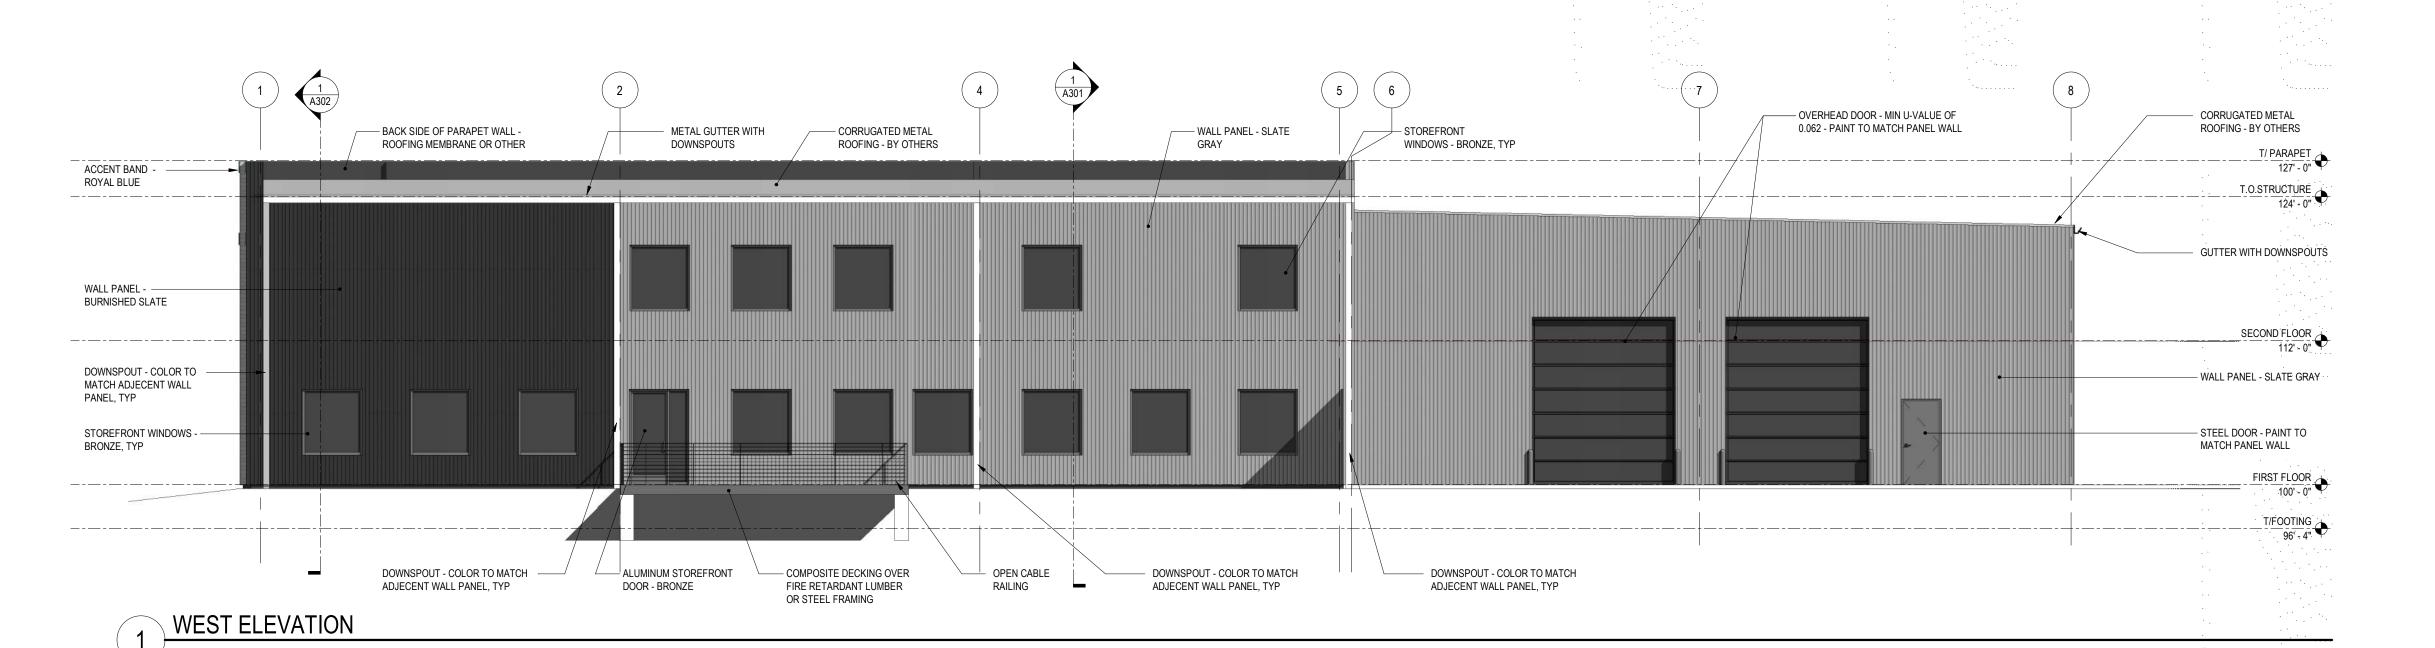
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RACE

EXTERIOR ELEVATION NOTES:

1. BRICK CLAD EXTERIOR WALLS TO BE FIELD FRAMED WITH 6" STEEL FRAMING
2. PANEL WALLS AND FINISHES ARE BY OTHERS
3. STOREFRONT SILL HEIGHT IS 2' - 6", TYPICAL WINDOW HEIGHT 5' - 6", UNO
4. WINDOWS AND DOORS TO BE INSTALLED AND FLASHED PER
MANUFACTURER'S INSTRUCTIONS AND INDUSTRY STANDARDS



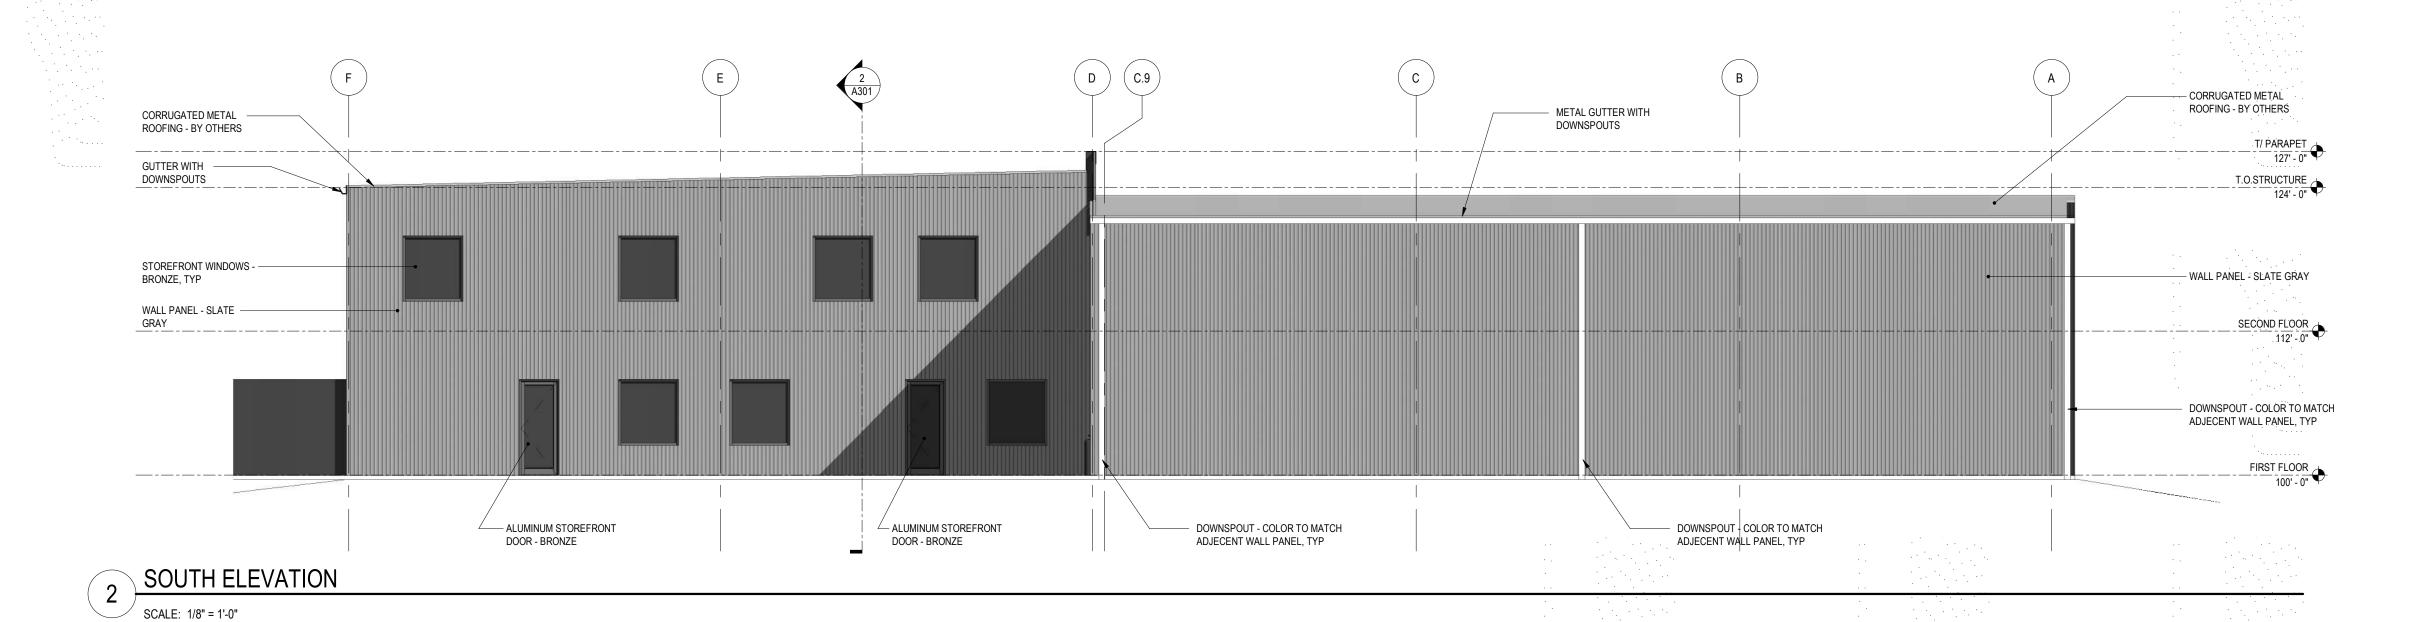

SCALE: 1/8" = 1'-0"

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• • • • •

EXTERIOR
ELEVATIONS

Scale: 1/8" = 1'-0"

A202













ABC WALL PANEL - ARCHITECTURAL III



BURNISHED SLATE



SLATE GRAY



NOTE: COPING TRIM AND DOWNSPOUTS TO MATCH WALL COLOR WHERE NOT INDICATED OTHERWISE

EXTERIOR BRICK





STOREFRONT DOORS AND WINDOWS - COLOR: BRONZE

WHITE TUMBLED BRICK - MANUFACTURER TBD



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CORNER OF SEMINOLE HWY AND S FITCHBURG, WI

RACE DAY EVENTS

SUB-ZERO PKWY

10 ARCHITECTURAL REVIEW 4.23.19
9 SCHEMATIC REVISION 3.24.19
No. Description Date

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Sheet Name

EXTERIOR RENDERINGS

Scale:

Sheet Number

A901